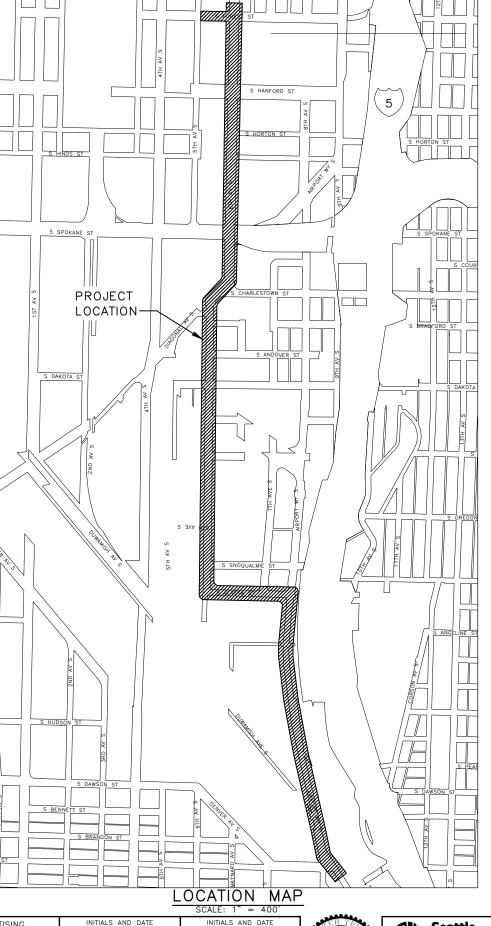


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SHEET INDEX					
SHEET	DRAWING	SHEET DESCRIPTION			
01	CV01	COVER			
02	NT01	GENERAL NOTES			
03-13	SV01-SV11	SURVEY CONTROL PLANS			
14-16	RS01-RS03	ROADWAY SECTIONS			
17-23	SP01-SP07	SITE PREPARATION PLANS			
24-25	DP01-DP02	STORM DRAINAGE PLANS			
26	SG01	SIGNAL LEGEND, ABBREVIATIONS, AND NOTES			
27-33	SG02-SG08	SIGNAL PLANS AND SCHEDULES			
34-37	LT01-LT04	PEDESTRIAN LIGHTING PLANS AND SCHEDULES			
38-49	PV01-PV12	PAVING PLANS			
50-55	PVDT01-PVDT06	PAVING DETAILS			
56-59	CR01-CR04	CURB RAMP PLANS			
60-76	CH01-CH18	CHANNELIZATION AND SIGNING PLANS			
77	CHDT01	CHANNELIZATION DETAILS			
78	SNDT01	SIGNAGE LEGEND AND SCHEDULE			
79	ST01	FOUNDATION DETAILS			

DETAIL AND SECTION REFERENCING


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DETAIL REFERENCE NUMBER SHEET ON WHICH DETAIL APPEARS

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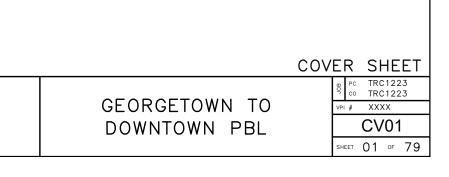
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-SECTION A-A IS SHOWN ON SHEET 32.

SECTION A-A 30 - SECTION A-A IS TAKEN FROM SHEET 30.



GENERAL NOTES

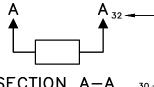UNLESS OTHERWISE NOTED ON THE DRAWINGS:

- 1 ALL WORK MUST CONFORM TO THE 2020 EDITION OF THE CITY OF SEATTLE STANDARD SPECIFICATIONS FOR ROAD, BRIDGE AND MUNICIPAL CONSTRUCTION, THE 2020 EDITION OF THE CITY OF SEATTLE STANDARD PLANS FOR MUNICIPAL CONSTRUCTION. AND THE SEATTLE DEPARTMENT OF TRANSPORTATION DIRECTOR'S RULE 01-2017 FOR STREET AND SIDEWALK PAVEMENT OPENING AND RESTORATION. A COPY OF THESE DOCUMENTS MUST BE ONSITE DURING CONSTRUCTION.
- 2. FOR REQUIREMENTS REGARDING THE PROTECTION AND RESTORATION OF PUBLIC AND PRIVATE PROPERTY SEE SECTIONS 1-07.16 & 1-07.17.
- 3. THE CONTRACTOR IS RESPONSIBLE FOR REFERENCING AND REPLACING ALL SURVEY MONUMENTS THAT MAY BE DISTURBED, DESTROYED OR REMOVED BY THE PROJECT AND AT LEAST 2 WORKING DAYS PRIOR TO THE WORK, MUST FILE AN APPLICATION FOR PERMIT TO REMOVE OR DESTROY A SURVEY MONUMENT WITH THE WASHINGTON STATE DEPARTMENT OF NATURAL RESOURCES, PURSUANT TO WAC 332-120. THE CONTRACTOR MUST PROVIDE THE ENGINEER AND SPU LAND SURVEY WITH A COPY OF THE APPROVED PERMIT AND COMPLETION REPORT. SEE STANDARD SPECIFICATION 1-07.28 ITEM 17.
- 4. TREES, SHRUBS AND OTHER PLANT MATERIAL NOT DESIGNATED FOR REMOVAL MUST BE PROTECTED FROM DAMAGE. SEE SECTIONS 1-07.16(2) AND 8-01 FOR REQUIREMENTS REGARDING THE TREE, VEGETATION AND SOIL PROTECTION PLAN.
- 5. THE PROJECT WILL INVOLVE EXCAVATION OVER CHARGED WATER MAINS. FOR PROTECTION OF THIS INFRASTRUCTURE, SEE SECTIONS 1-07.16(1) AND 2-02.3(3)C. CONTRACTOR MUST NOT REPAIR DAMAGE TO CHARGED WATER MAINS OR SERVICES BUT MUST IMMEDIATELY NOTIFY THE SPU EMERGENCY DISPATCHER AT 206-386-1800.
- 7. RESTORATION OF CONTRACTOR DAMAGE TO EXISTING UTILITIES MUST BE AT THE CONTRACTOR'S EXPENSE. SEE SECTIONS 1-07.13 AND 1-07.16.
- 8. THE CONTRACTOR MUST NOTIFY THE UTILITIES FOR UNDERGROUND UTILITY LOCATIONS BEFORE COMMENCEMENT OF ANY EXCAVATION. ADVANCE NOTIFICATION IS REQUIRED. SEE SECTION 1-07.28.
- FOR NOTIFICATION AND COORDINATION REQUIREMENTS, INCLUDING COMMUNICATION WITH METRO TRANSIT, SEE SECTIONS 1-07.17 AND 1-07.28.
- 10 ALL EXCAVATIONS ADJACENT TO SEATTLE CITY LIGHT POLES OR OTHER FACILITIES (VAULTS, HANDHOLES, ETC.) MUST COMPLY WITH WAC 296-155 PART N, EXCAVATION, TRENCHING AND SHORING. POLE PROTECTION / SUPPORTING SYSTEMS USED WHILE EXCAVATING MUST COMPLY WITH WAC 296-155-655, GENERAL PROTECTION REQUIREMENTS, ITEM (9) AND MUST NOT AFFECT THE STRUCTURAL INTEGRITY OF POLES WHILE THE SYSTEMS ARE IN PLACE OR AFTER THE SYSTEMS HAVE BEEN REMOVED

STORMWATER POLLUTION PREVENTION NOTES

UNLESS OTHERWISE NOTED ON THE DRAWINGS:

THE CONTRACTOR MUST PREPARE A CONSTRUCTION STORMWATER AND EROSION CONTROL PLAN (CSECP), A TREE, VEGETATION AND SOIL PROTECTION PLAN (TVSPP) AND A SPILL PLAN (SP) FOR APPROVAL BY THE ENGINEER PRIOR TO CONSTRUCTION. SEE SECTIONS 1-07.15 AND 8-01.

METRO COORDINATION NOTES

NWC

6 3

- TO SCHEDULE BUS SHELTER REMOVAL BY METRO CONTACT PLANSREVIEW@KINGCOUNTY GOV ADVANCE NOTIFICATION OF 3 WEEKS IS REQUIRED. SEE SECTION 1-07.28 ITEM 4.
- 2. ALL METRO SHELTER FOOTINGS MUST BE INSPECTED BY METRO BEFORE ANY CONCRETE IS POURED. CONTACT METRO INSPECTORS AT 206-263-1370 OR 206-947-1574 OR PAUL.MILLER@KINGCOUNTY.GOV. ADVANCE NOTICE OF 3 WORKING DAYS IS REQUIRED.
- 3. AFTER BUS SHELTER FOOTINGS ARE INSTALLED, CONTACT PLANSREVIEW@KINGCOUNTY.GOV TO SCHEDULE BUS SHELTER FRAME INSTALLATION AND BUS STOP FLAG POST INSTALLATION.

ROADWAY NOTES UNLESS OTHERWISE NOTED ON THE DRAWINGS:

- 1. PAVEMENT, SIDEWALK AND CURB REMOVALS MUST EXTEND TO EXISTING JOINTS, TO LIMITS IDENTIFIED AS "SAWCUT" ON THE DRAWINGS, OR TO LIMITS DETERMINED BY THE ENGINEER. SEE SECTION 2-02.3
- 2. ALL JOINTS AT THE MEET LINES OF NEW CONSTRUCTION AND EXISTING SURFACES MUST BE BUTT JOINTS. SEE SECTION 5-04.3(10)B.
- 3. LONGITUDINAL JOINTS MUST BE COORDINATED WITH THE CHANNELIZATION DRAWINGS. LONGITUDINAL JOINTS MUST BE AT A LANE LINE OR EDGE OF TRAVELED WAY UNLESS APPROVED OTHERWISE IN WRITING BY THE ENGINEER. SEE SECTION 5-05.3(8)E2.
- 4. PAVING AROUND INLETS AND CATCH BASINS MUST BE SLOPED TO ESTABLISH A DRAINAGE TRANSITION ZONE PER STANDARD PLAN 260A
- 5. HMA SURFACE COURSE FOR ROADWAY MUST BE CLASS 1/2", PG58H-22 FOR 10 MILLION ESAL'S.
- 6. HMA BASE COURSE FOR ROADWAY MUST BE CLASS 1". PG58V-22 FOR 10 MILLION ESAL'S
- 7. PRIOR TO SAWCUT AND REMOVAL FOR BASE REPAIR, THE CONTRACTOR MUST HAVE THE LIMITS VERIFIED BY THE ENGINEER. THE OWNER RESERVES THE RIGHT TO IDENTIFY ADDITIONAL AREAS OF BASE REPAIR AFTER PLANING.
- 8. IF AN EXISTING WATER VALVE BOX REQUIRES ADJUSTMENT, IT MUST BE DONE BY EXCAVATING THE CASTING AND VERTICALLY ADJUSTING THE TOP SECTION OF THE VALVE BOX. THE FLANGE MUST BE CAST IN TO SURROUNDING PAVEMENT AS SHOWN ON STD PLAN 315. DO NOT USE EXTENSION RINGS. SEE SECTION 7-20.3(1)A.
- 9. CONTRACTOR MUST ADJUST CASTINGS IN ACCORDANCE WITH SECTION 7-20. CASTINGS MUST BE ADJUSTED TO FINISH GRADE PRIOR TO CONSTRUCTION OF FINAL SURFACE COURSE PER SECTION 5-04.3(9)B. WORN OR BROKEN CASTINGS TO BE REPLACED MUST BE REPLACED PRIOR TO INSTALLATION OF THE FINAL SURFACE.
- 10. NEW LOOP DETECTORS MUST BE INSTALLED IN THE PAVEMENT SUBLAYER PRIOR TO FINAL WEARING COURSE PAVING. SEE SECTION 8-31.3(5)A. WHEN INSTALLING IN NEW FULL DEPTH CONCRETE PAVEMENT WITHOUT ASPHALT SURFACING, THE LOOPS MUST BE PREFORMED PER SECTION 8-31.3(5)B

CURB RAMP NOTES:

UNLESS OTHERWISE NOTED ON THE DRAWINGS:

- 1. ALL NEWLY CONSTRUCTED PEDESTRIAN ACCESS ROUTES INCLUDING SIDEWALK AND CURB RAMPS MUST MEET CURRENT ADA STANDARDS AND GUIDELINES (2010 ADA STANDARDS, PROWAG 2011) TO THE MAXIMUM EXTENT FEASIBLE
- 2. WHERE THE DRAWINGS DENOTE "MEF" FOR CURB RAMP ELEMENTS, THIS DESIGNATION IS FOR THE REFERENCE ONLY AND MUST BE FIELD VERIFIED BY THE ENGINEER. THE CONTRACTOR MUST NOTIFY THE ENGINEER PER SECTION 8-14.3(7) AND ALLOW THE ENGINEER THE OPPORTUNITY TO INSPECT THE CURB RAMP LAYOUT AND DIRECT ADJUSTMENTS AS NECESSARY. EVERY EFFORT WILL BE MADE TO ACHIEVE AN ADA COMPLIANT RAMP.
- 3. THE CONTRACTOR MUST NOTIFY THE ENGINEER IF A CURB RAMP CANNOT BE CONSTRUCTED PER THE DRAWINGS, RESULTING IN A NON-COMPLIANT SLOPES AN/OR DIMENSIONS. PRIOR TO INSTALLING THE CURB RAMP. THE ENGINEER MUST APPROVE THE CURB RAMP LAYOUT.
- 4. PEDESTRIAN ACCESS THROUGH THE PROJECT MUST BE MAINTAINED IN COMPLIANCE WITH SDOT PEDESTRIAN MOBILITY IN AND AROUND WORK ZONES, DIRECTOR'S RULE 10-2015, AND SDOT 2018 TRAFFIC CONTROL MANUAL FOR IN-STREET WORK
- 5. FOR ASSET MANAGEMENT PURPOSES. THIS PROJECT INCLUDES THE FOLLOWING:

NEW CURB RAMPS	1
REBUILT CURB RAMPS	7
PROJECT TOTAL	7

SIGNAL NOTES

UNLESS OTHERWISE NOTED ON THE DRAWINGS:

- 1. THE CONTRACTOR MUST IMMEDIATELY REPORT ANY DAMAGE TO THE TRAFFIC SIGNAL SYSTEM, INCLUDING CONDUIT AND THE DETECTOR LOOPS. SEE SECTION 1-07.28 NOTE 16.
- 2. THE TRAFFIC SIGNAL SYSTEM INTERCONNECT CABLE AND SIGNAL WIRE SERVICE, VIDEO, OR MASTER CABLE MUST NOT BE SPICED. SEE SECTIONS 8-31.3(8)A AND 8-31.3(9)B.
- 3. THE CONTRACTOR MUST CONTACT SDOT TRAFFIC SIGNAL OPERATIONS WHEN THE TRAFFIC SIGNAL SYSTEMS OR THE TRAFFIC DETECTOR LOOPS MAY BE IMPACTED BY CONSTRUCTION. ADVANCE NOTIFICATION IS REQUIRED. SEE SECTION 1-07.28, SIGNALIZED INTERSECTIONS.
- 4. THE CONTRACTOR MUST PROVIDE PRELIMINARY LAYOUT FOR THE TRAFFIC DETECTION. THE LAYOUT MUST BE VERIFIED BY THE ENGINEER PRIOR TO SAW CUTTING. ADVANCE NOTIFICATION IS REQUIRED. SEE SECTION 8-31.3(5)A.

60% SUBMITTAL NOT FOR CONSTRUCTION JUNE 2023

XXXX-XX	DEPARTMENT OF FINANCE & ADMINISTRATIVE SERVICES SEATTLE, WASHINGTON	INITIALS AND DATE DESIGNED CHECKED	INITIALS AND DATE REVIEWED: DES. CONST. SDOT PROJ. MGR.		Seattle Department of Transportation
****		DRAWN CHECKED	RECEIVED REVISED AS BUILT	51781 SITER	ORDINANCE NO. PW NO. XXXX-XX
	PURCHASING AND CONTRACTING	ALL WORK SHALL BE DONE IN ACCORDANCE WITH SPECIFICATIONS AND OTHER DOCUMENTS CALLED FO		TONAL W	SCALE: H. 1"=20', V. 1"=10'

SIGNING & CHANNELIZATION NOTES UNLESS OTHERWISE NOTED ON THE DRAWINGS:

- SERIES STANDARD PLANS.

DRAINAGE NOTES

- STD PLAN 285.
- IN ADVANCE

TREE PROTECTION NOTES UNLESS OTHERWISE NOTED ON THE DRAWINGS:

- 3. AIRSPADING REQUIRED NECESSARY.
- TRENCHING.
- CONCRETE IS INSTALLED

1. TO ORDER SDOT PROVIDED SIGNS, OR TO COORDINATE SDOT'S INSTALLATION OF SIGNS, SEE SECTION 8-21.3(1). ADVANCE NOTIFICATION IS REQUIRED. CONTACT SDOT SIGNS AND MARKING SHOP AT (206)233-7104.

2. FOR REQUIREMENTS ON LAYOUT AND VERIFICATION OF CHANNELIZATION FEATURES, SEE SECTION 8-22.3(1). ADVANCE NOTIFICATION IS REQUIRED. CONTACT CARTER DANNE AT (206)684-0817 FOR CHAN REVIEW.

3. FOR SIGNING AND STRIPING DETAILS NOT SHOWN IN THESE DRAWINGS, SEE 600 SERIES AND 700

UNLESS OTHERWISE NOTED ON THE DRAWINGS:

1. FOR INLET CONNECTION BEND AND SLOPE RESTRICTIONS, SEE SECTION 7-08.3(5)

2. WHEN CONNECTING TO EXISTING SEWER AND DRAINAGE LINES. THE CONTRACTOR MUST VERIFY INVERT ELEVATIONS PRIOR TO CONSTRUCTION. DISCREPANCIES IN INVERT ELEVATIONS MUST BE IMMEDIATELY BROUGHT TO THE ATTENTION OF THE ENGINEER

3. BEDDING FOR INLET CONNECTION AND CATCH BASIN CONNECTION PIPES MUST BE CLASS B. SEE

4. ALL INLET AND CATCH BASIN PIPE RECONNECTIONS MUST USE FLEXIBLE GASKETED COUPLINGS WITH STAINLESS STEEL SHIELDS PER SPECIFICATION 9-05.18.

5. SEATTLE PUBLIC UTILITIES (SPU) APPROVAL IS REQUIRED FOR ALL PROPOSED NEW CATCH BASINS. INLETS AND PIPES PRIOR TO FINAL SURFACE RESTORATION. CONTACT THE ENGINEER, 48 HOURS

6. DUCTILE IRON PIPE MUST BE ANSI A21.51 CLASS 50 WITH PUSH-ON JOINTS. FITTINGS FOR DUCTILE IRON PIPE MUST BE PER ANSI A21.10 OR ANSI A21.53 WITH PUSH-ON JOINTS. GLANDS ON MECHANICAL JOINT PIPE AND FITTINGS MUST BE DUCTILE. SEE SECTION 9-05.3.

7. WHERE MAINTENANCE HOLES OR CATCH BASINS REQUIRE A NEW OR REPLACED CASTING PER STD PLAN 230. CASTINGS IN ROADWAYS MUST BE 10-INCH MIN DEPTH

1 CONTRACTOR SHALL PREPARE A TREE SOIL AND VEGETATION PROTECTION WORK PLAN NOTE AND PHOTOGRAPH CONDITIONS AND MATERIALS IN EXISTING TREE PITS TO INCLUDING PAVERS FOR REVIEW BY SDOT URBAN FORESTRY

2. CONTRACTOR SHALL NOTIFY THE ENGINEER AND SDOT URBAN FORESTRY 72 HOURS MIN. PRIOR TO BOTH DEMOLITION AND EXCAVATION WITHIN THE TREE DRIP LINE.


ALL TRENCH EXCAVATION IN THE TREE DRIP LINE SHALL BE PERFORMED TO FULL DEPTH AND WIDTH OF EXCAVATION WITH AN AIRSPADE UNDER THE SUPERVISION OF SDOT URBAN FORESTRY ARBORIST, WATER SLUICING IS NOT ALLOWED. RETAIN ALL STRUCTURAL ROOTS (1 INCH OR GREATER) ACROSS TRENCHES. SDOT URBAN FORESTRY ARBORIST TO DIRECT ROOT PRUNING IF


4. AVOID DAMAGE TO ROOTS DURING CONCRETE SAWCUTTING, DEMOLITION, EXCAVATION AND

5. REMOVE PAVEMENT WITHIN TREE DRIPLINE BY SAWCUTTING FREQUENTLY (12 TO 18-INCHES O.C.) TO ALLOW SMALL PIECES TO BREAK OUT. IF PART OF PAVEMENT IS FIRMLY ATTACHED TO ROOTS GREATER THAN 1-INCH, PRUNE ROOTS UNDER SUPERVISION OF SDOT URBAN FORESTRY ARBORIST.


6 PROTECT TREE ROOTS AFTER EXPOSURE DUE TO CONCRETE REMOVAL AIRSPADING AND OTHER CONSTRUCTION ACTIVITY. ONLY EXCAVATE AND EXPOSE AREA OF ROOTS THAT CAN BE BACKFILLED AND COVERED WITHIN ONE WORKING DAY, MAINTAIN MOIST SUBGRADE CONDITION UNTIL NEW

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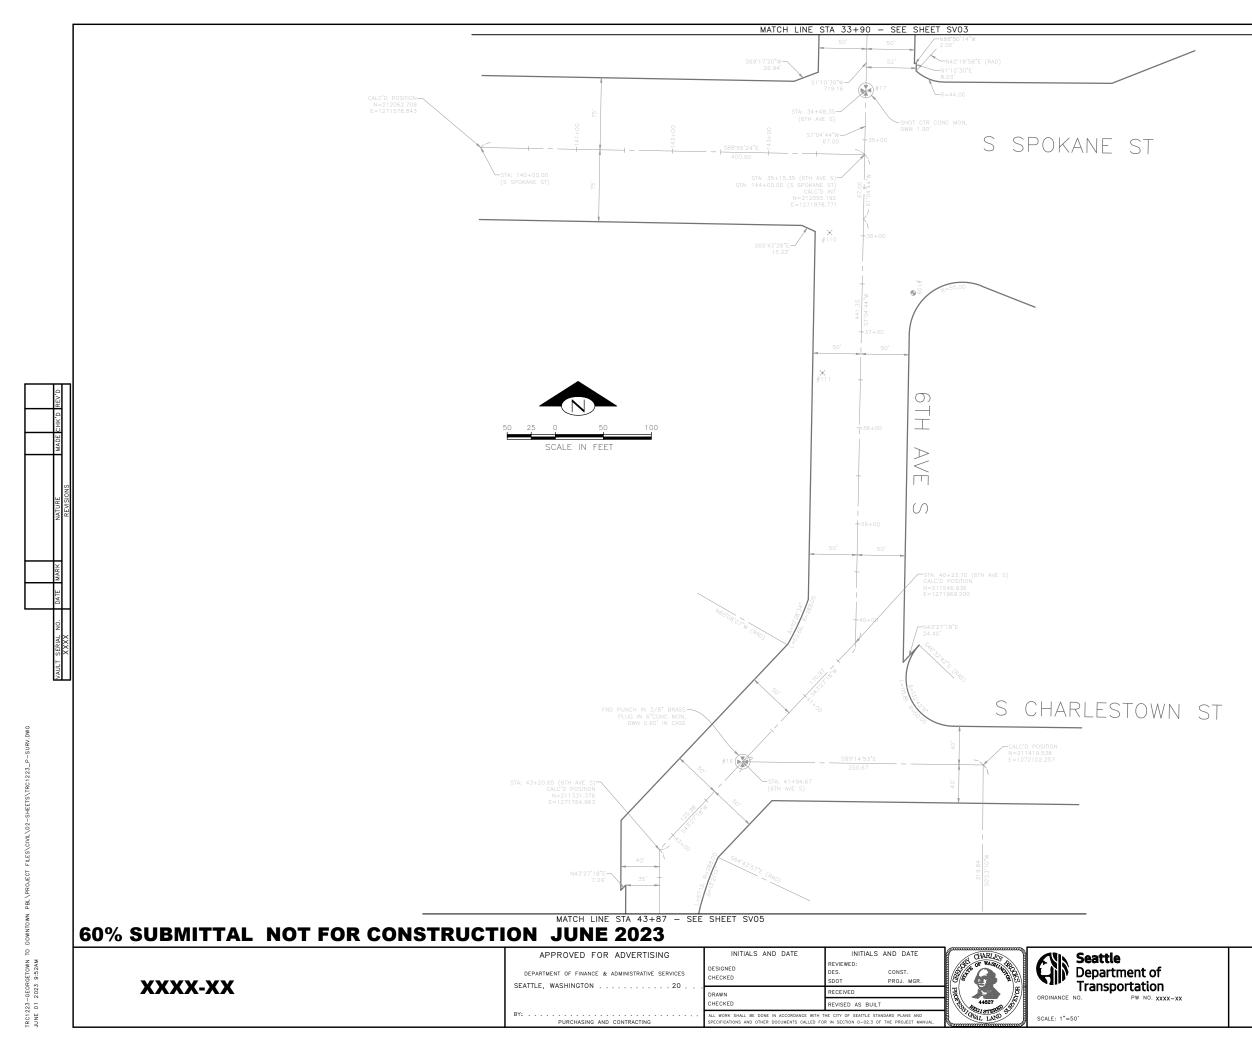


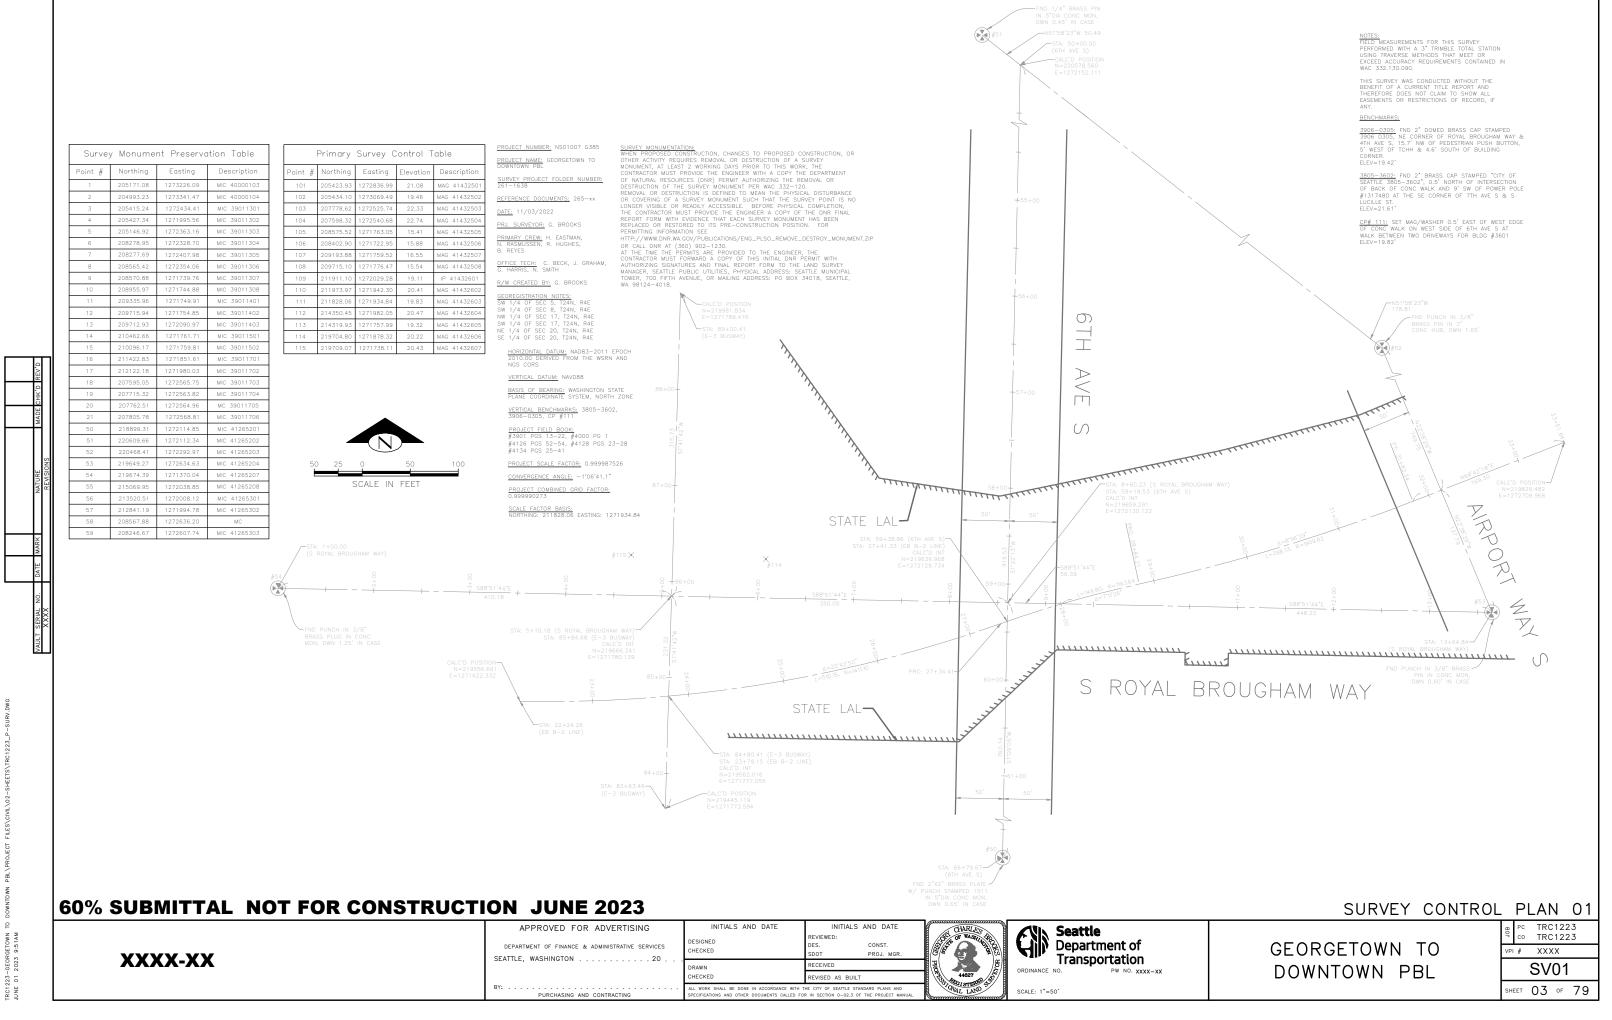

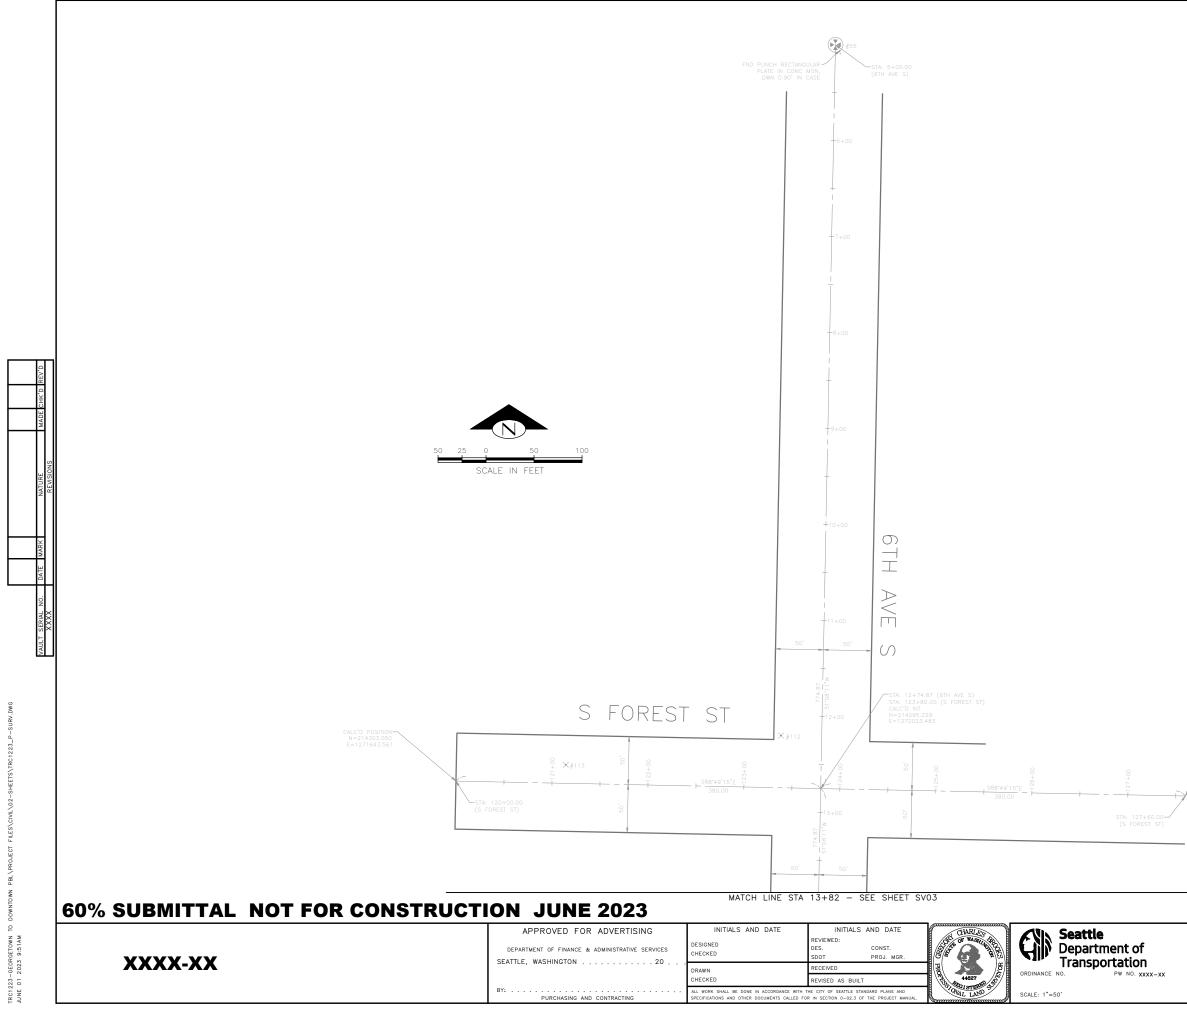
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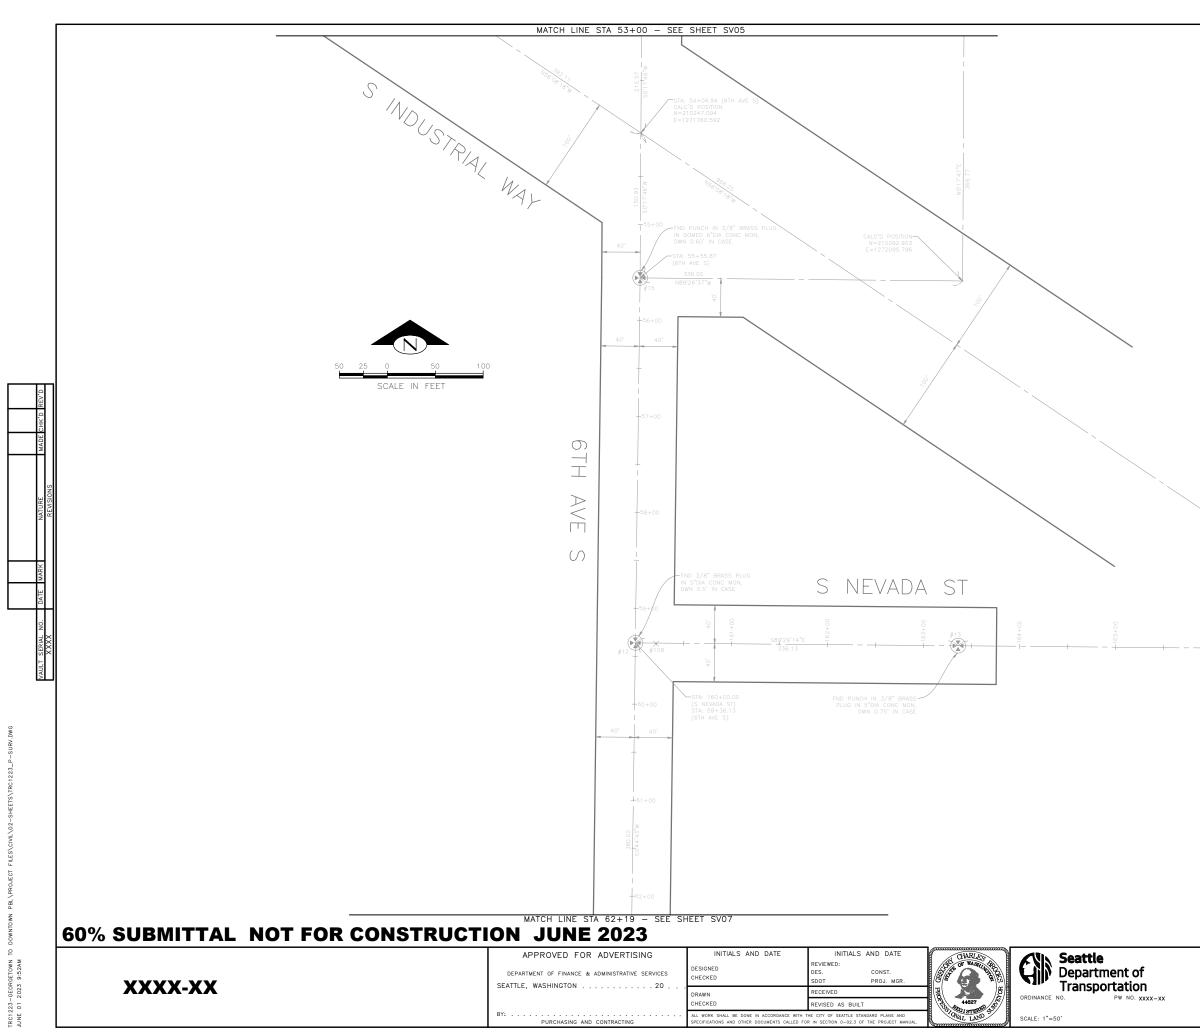
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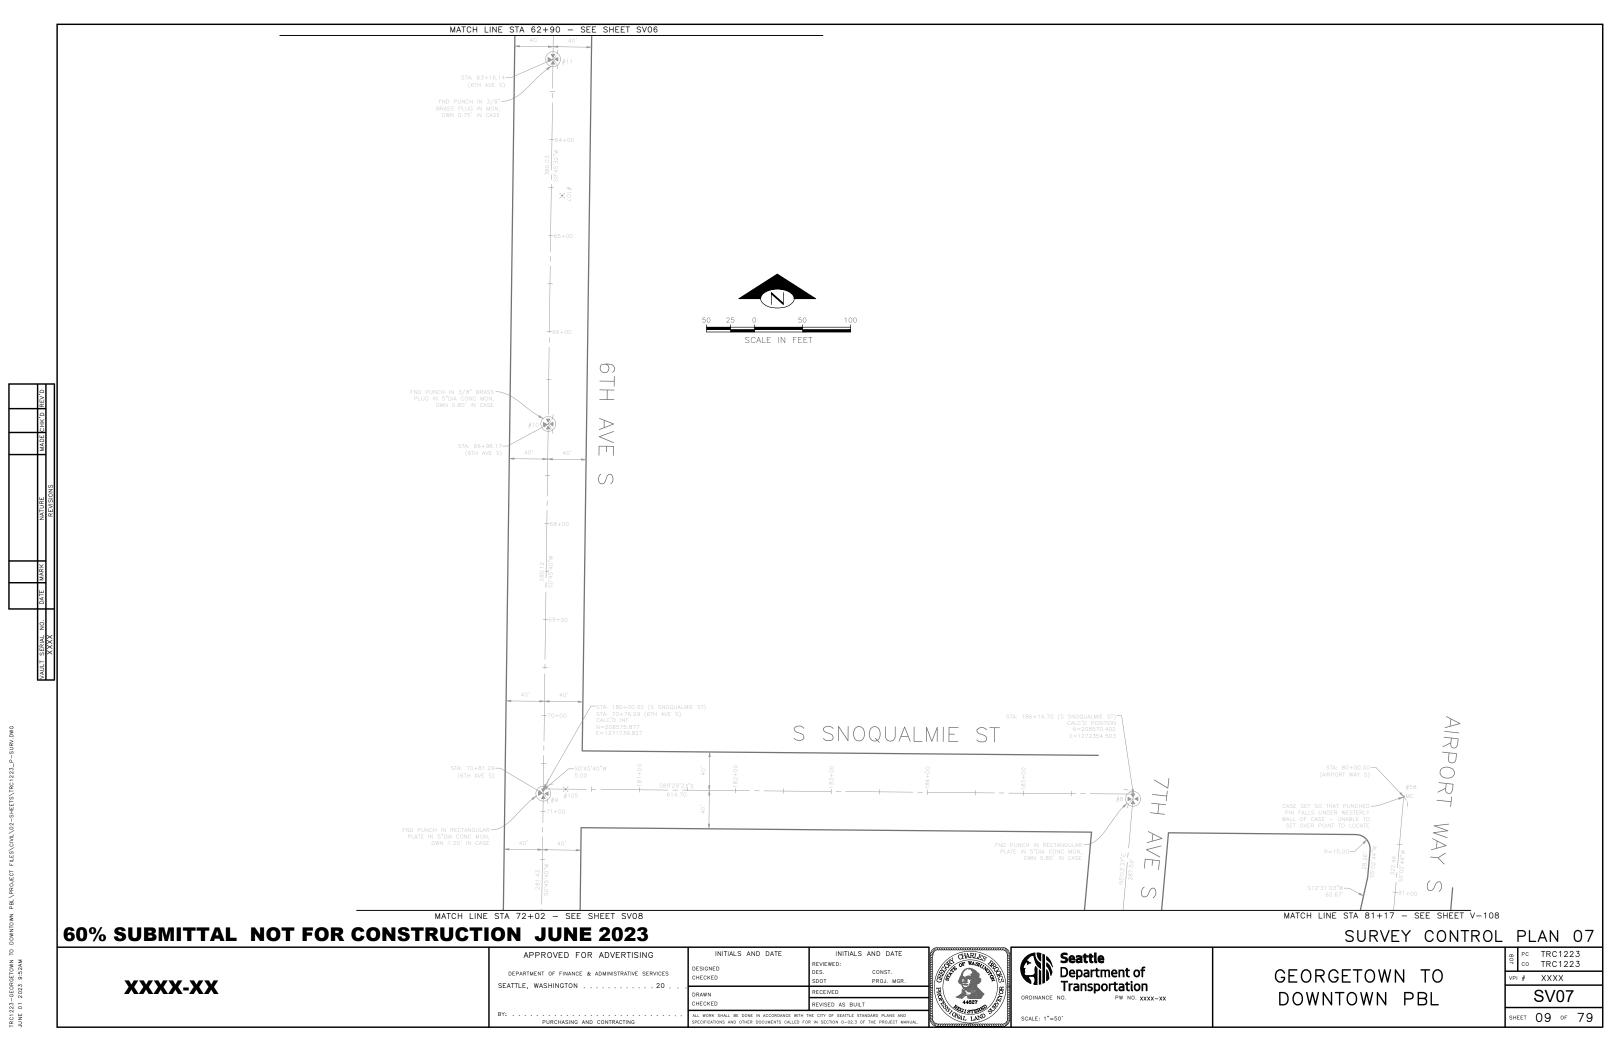
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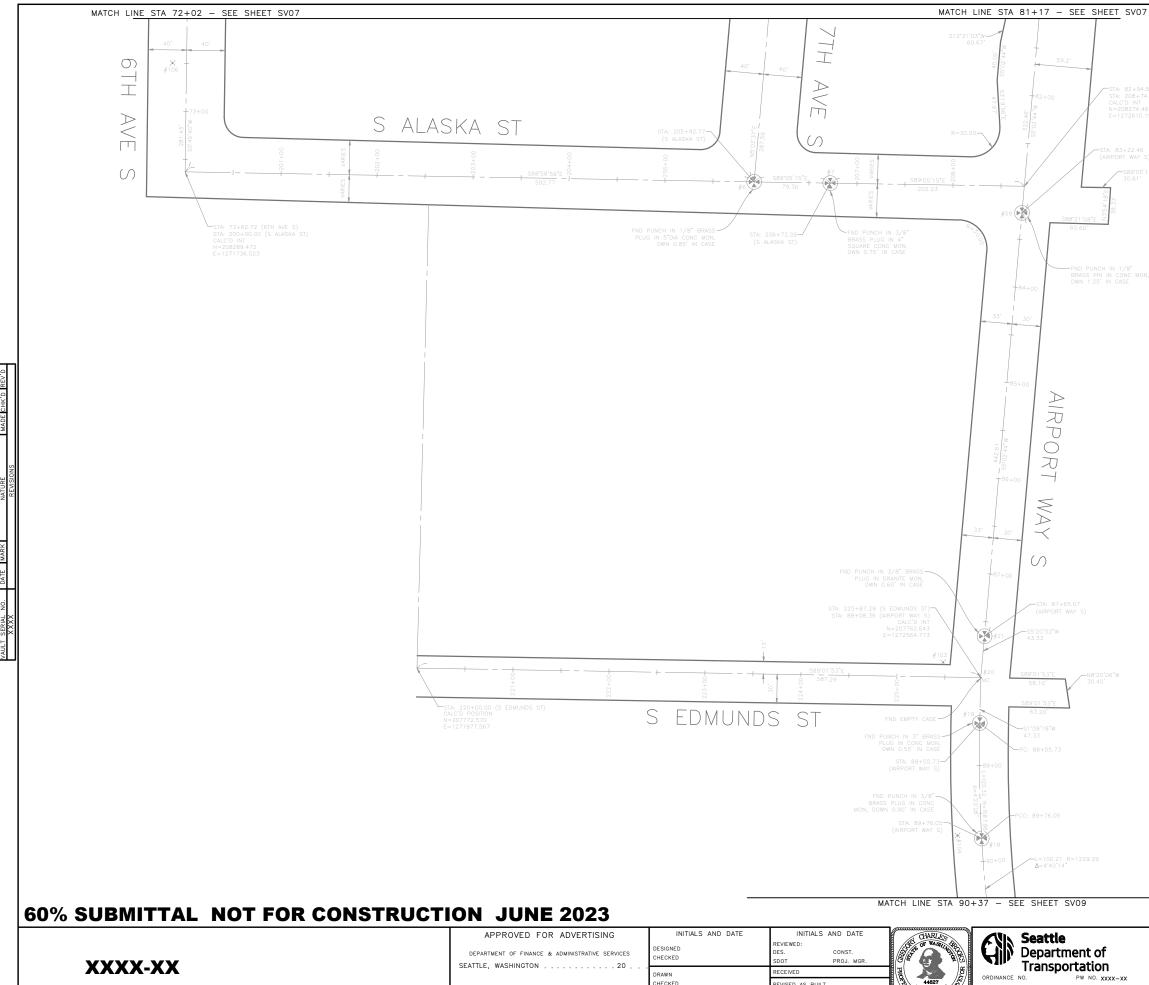


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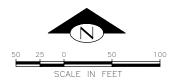
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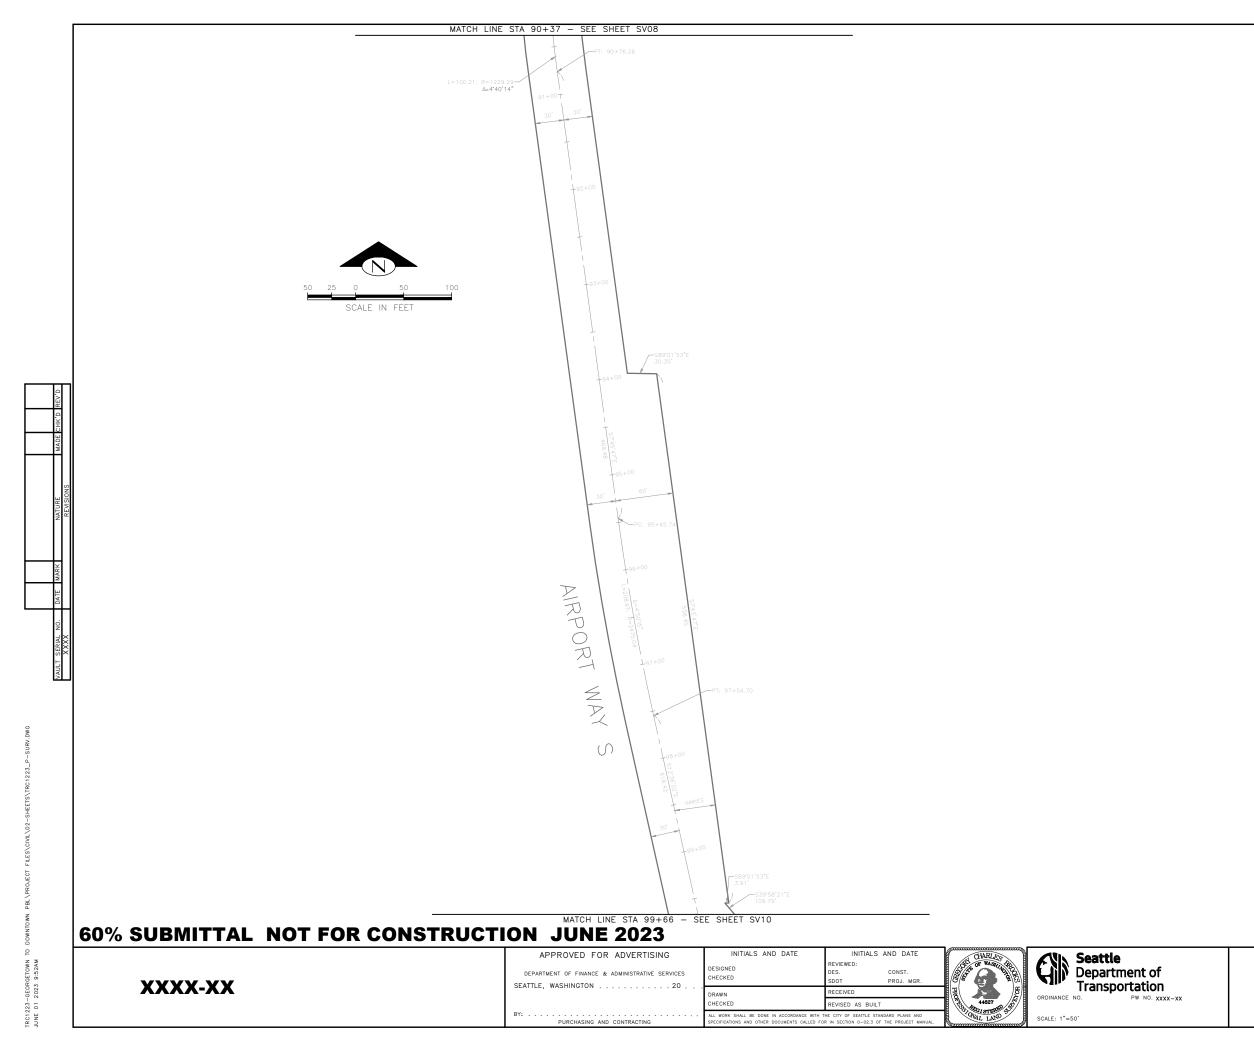
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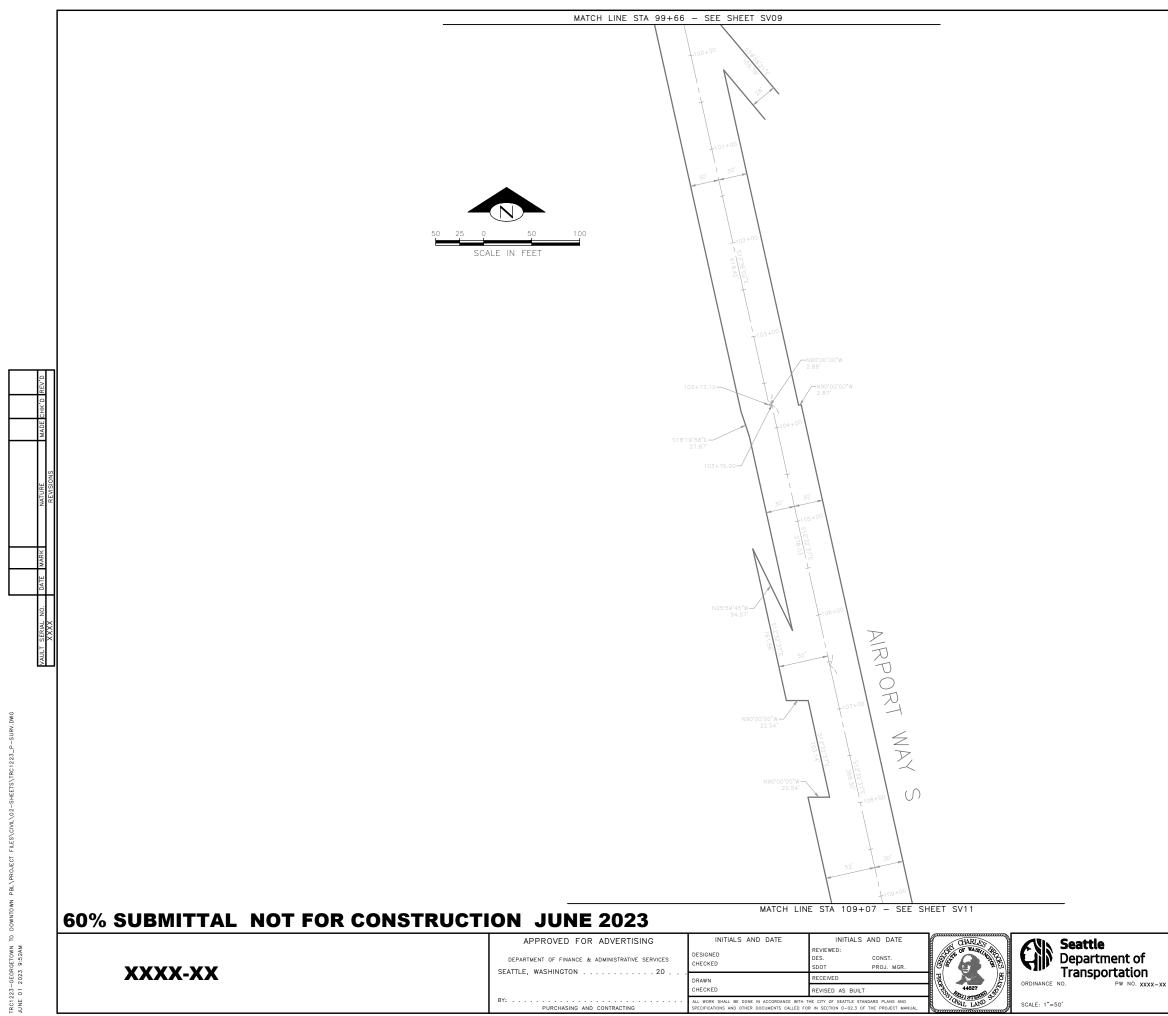
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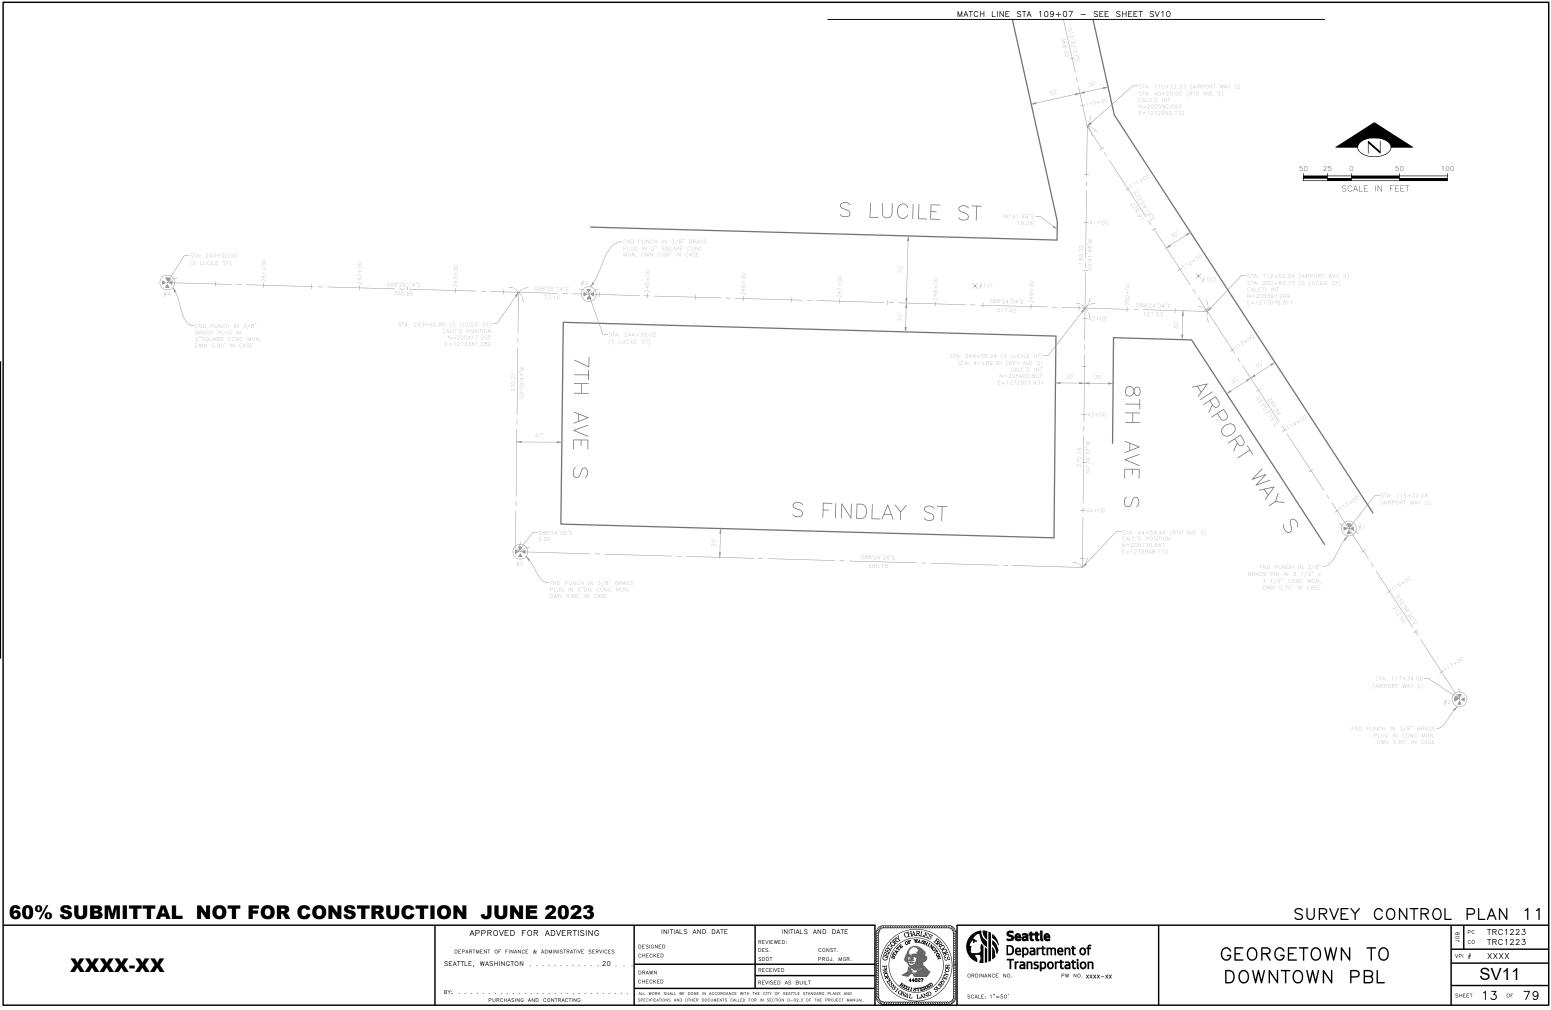

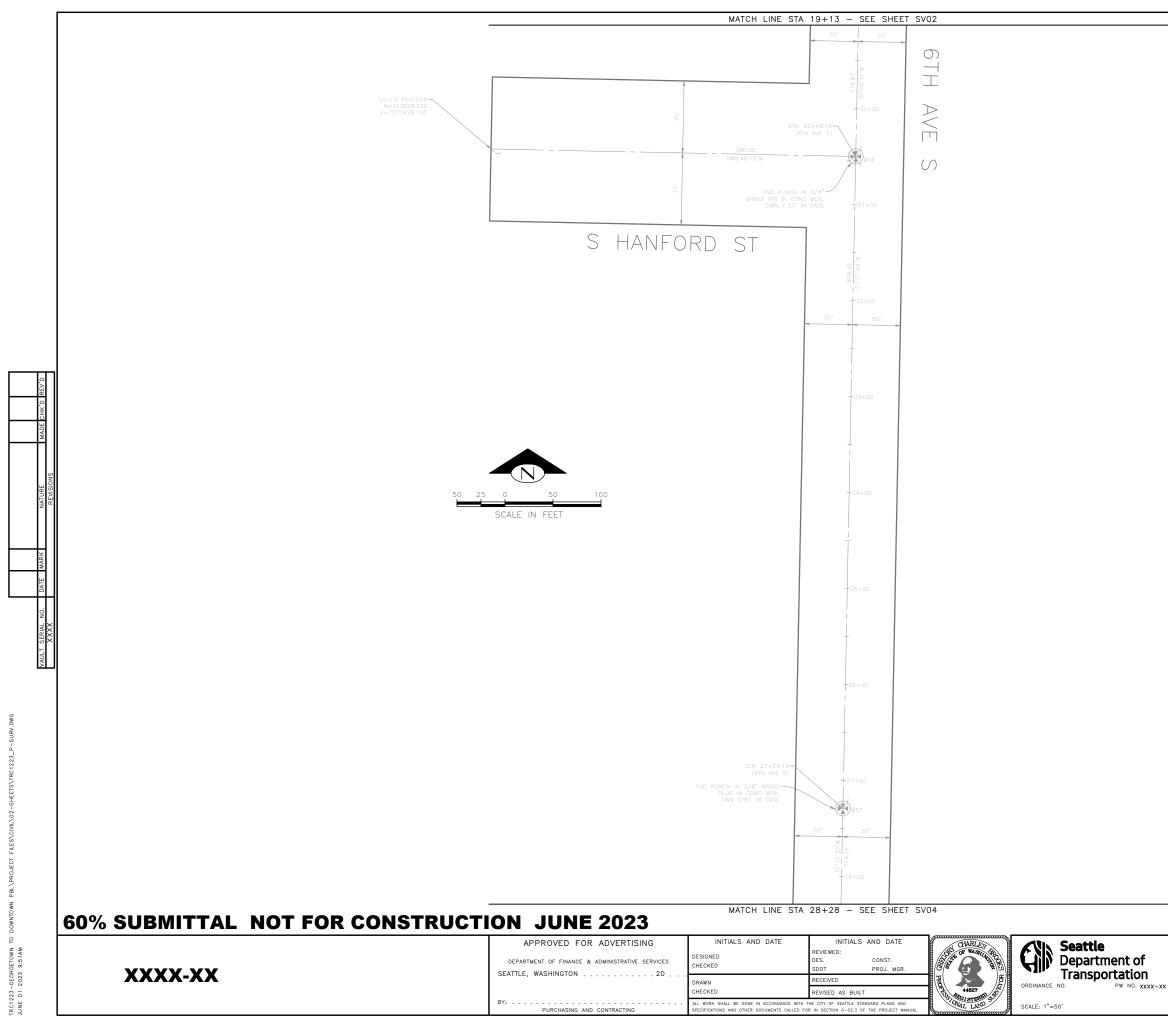
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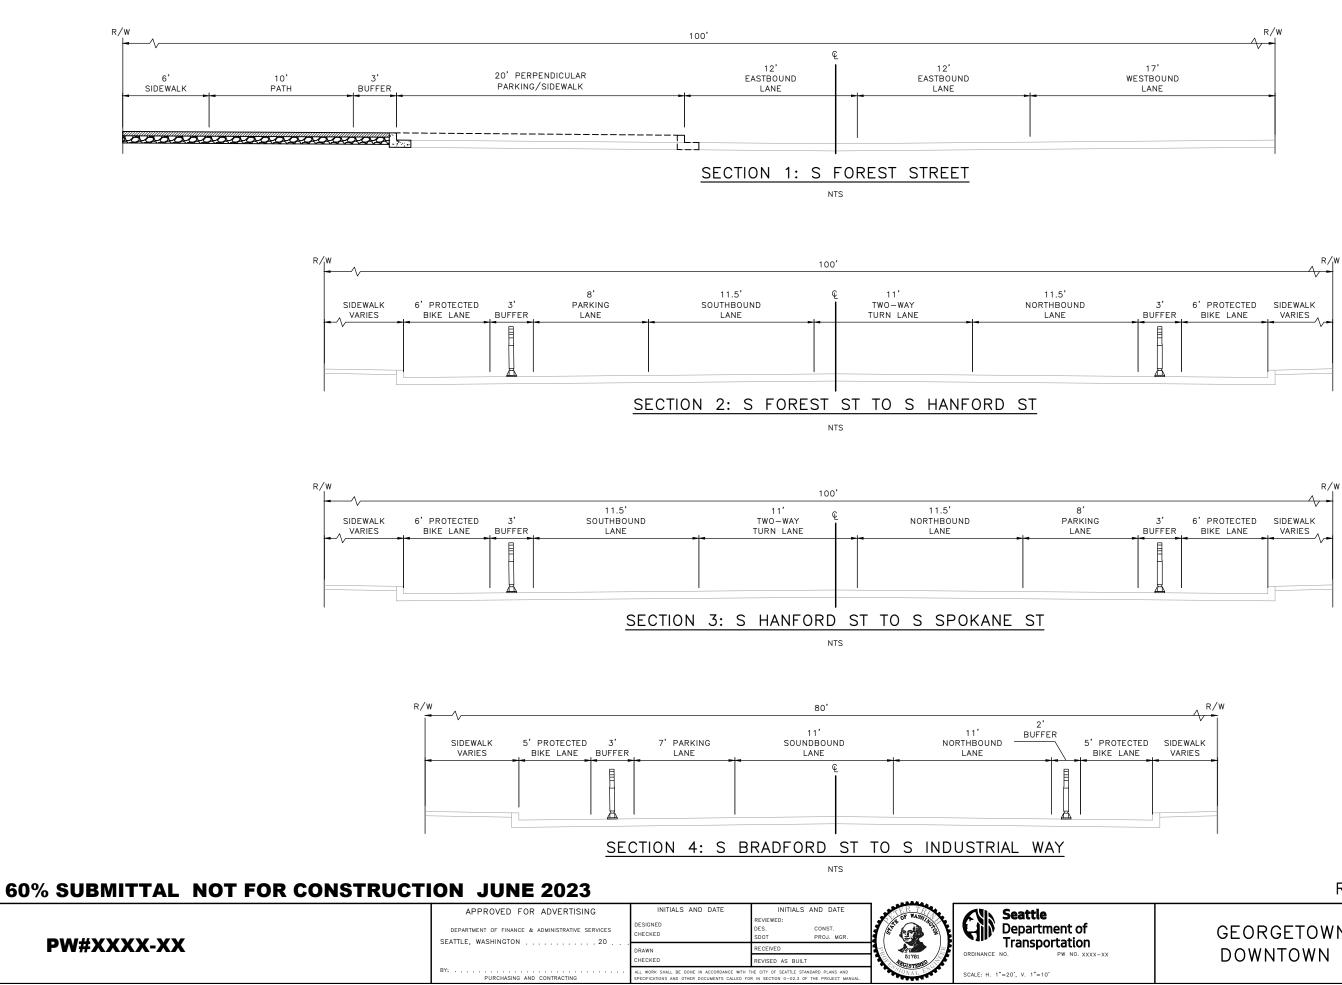
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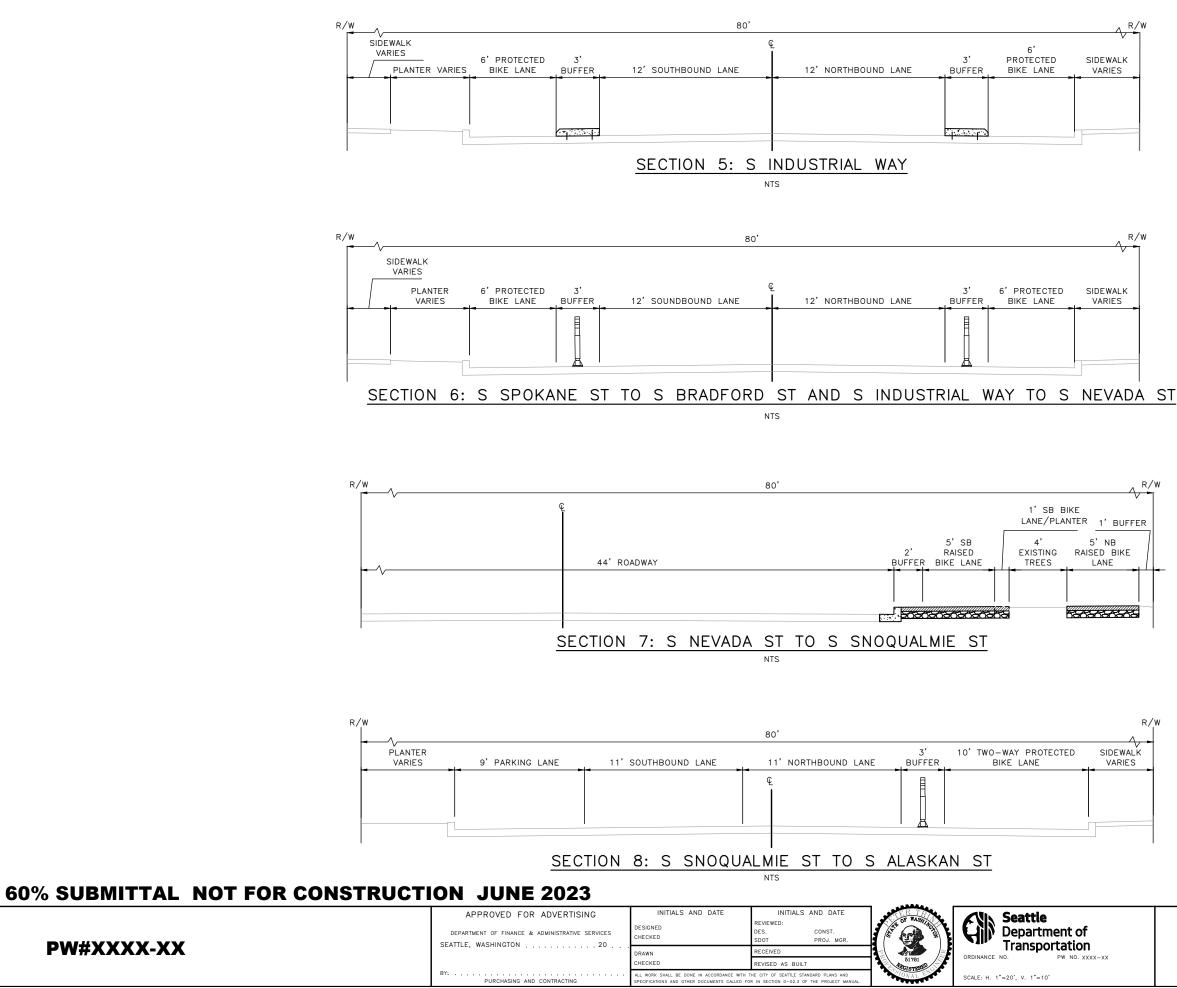
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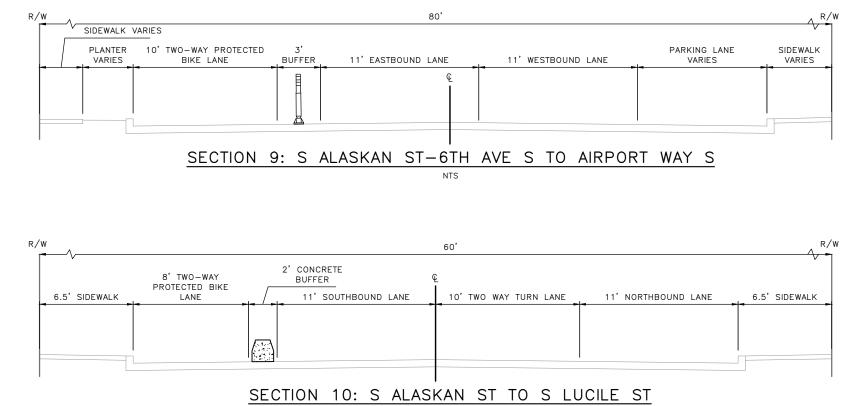
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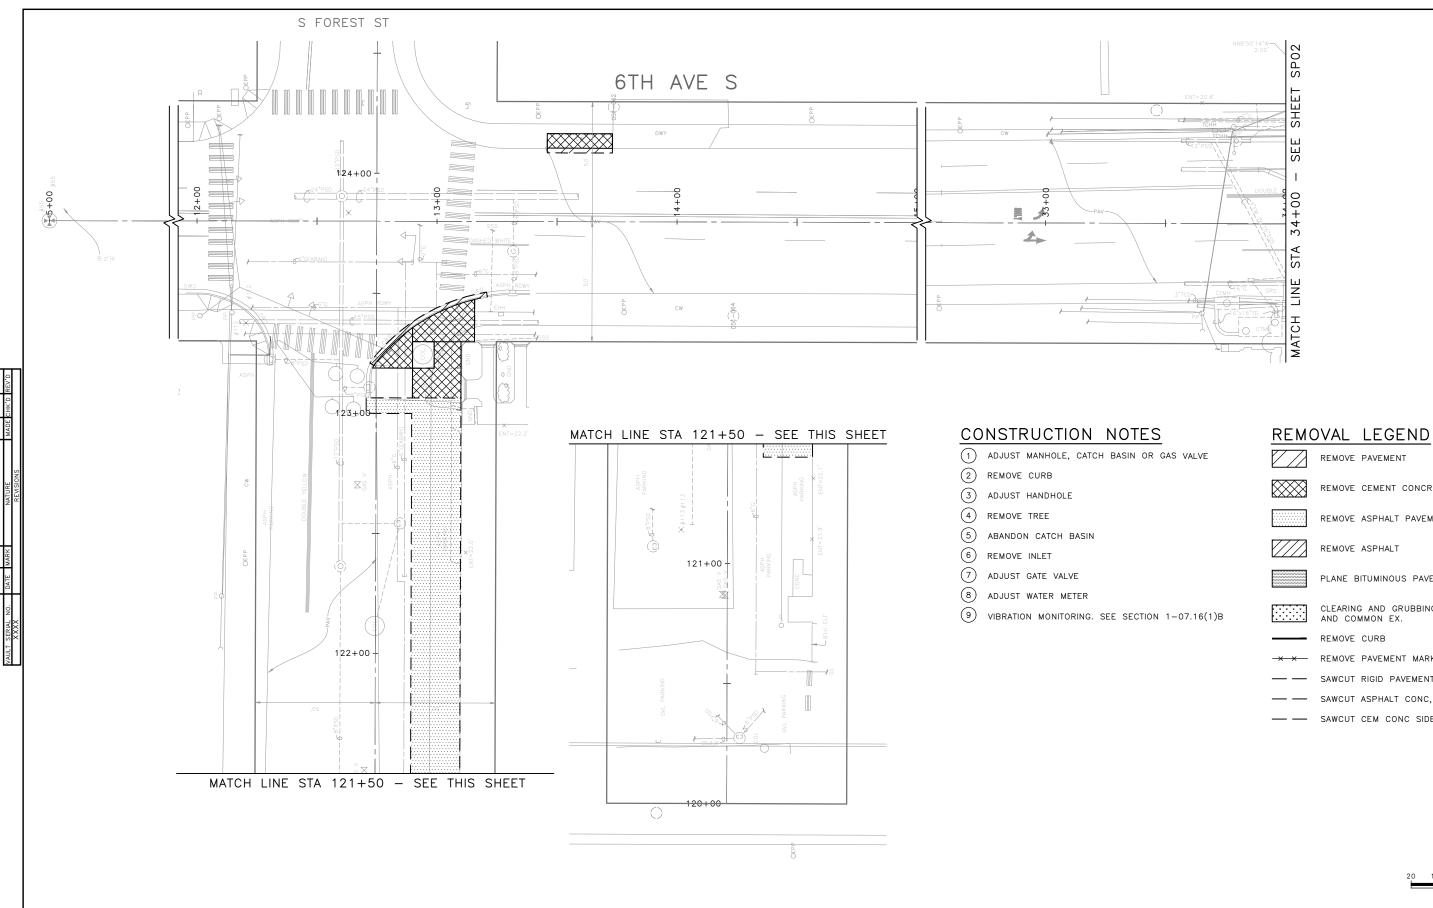
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ROADWAY SECTION 03

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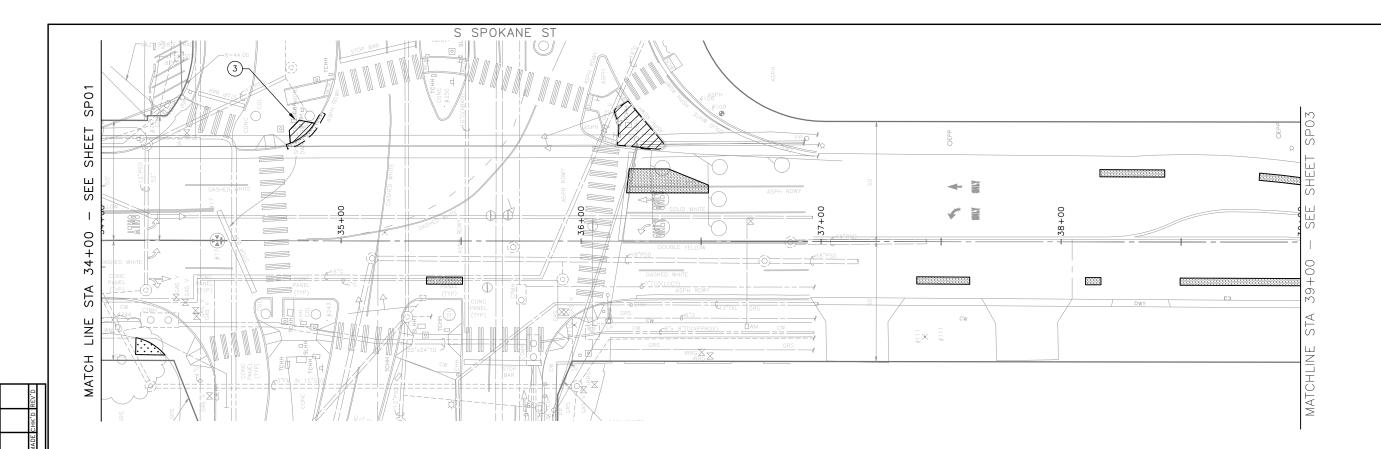
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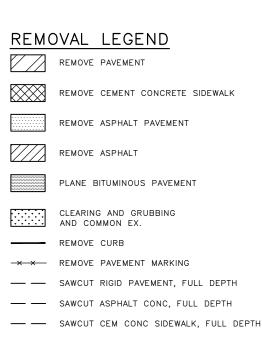
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		REMOVE CURB
	_ *_* _	REMOVE PAVEMENT MARKING
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		SAWCUT CEM CONC SIDEWALK, FULL DEPTH
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SITE PREPARATION PLAN 01 е ткс1223 со ткс1223 GEORGETOWN TO VPI # XXXX SP01 DOWNTOWN PBL SHEET 17 OF 79



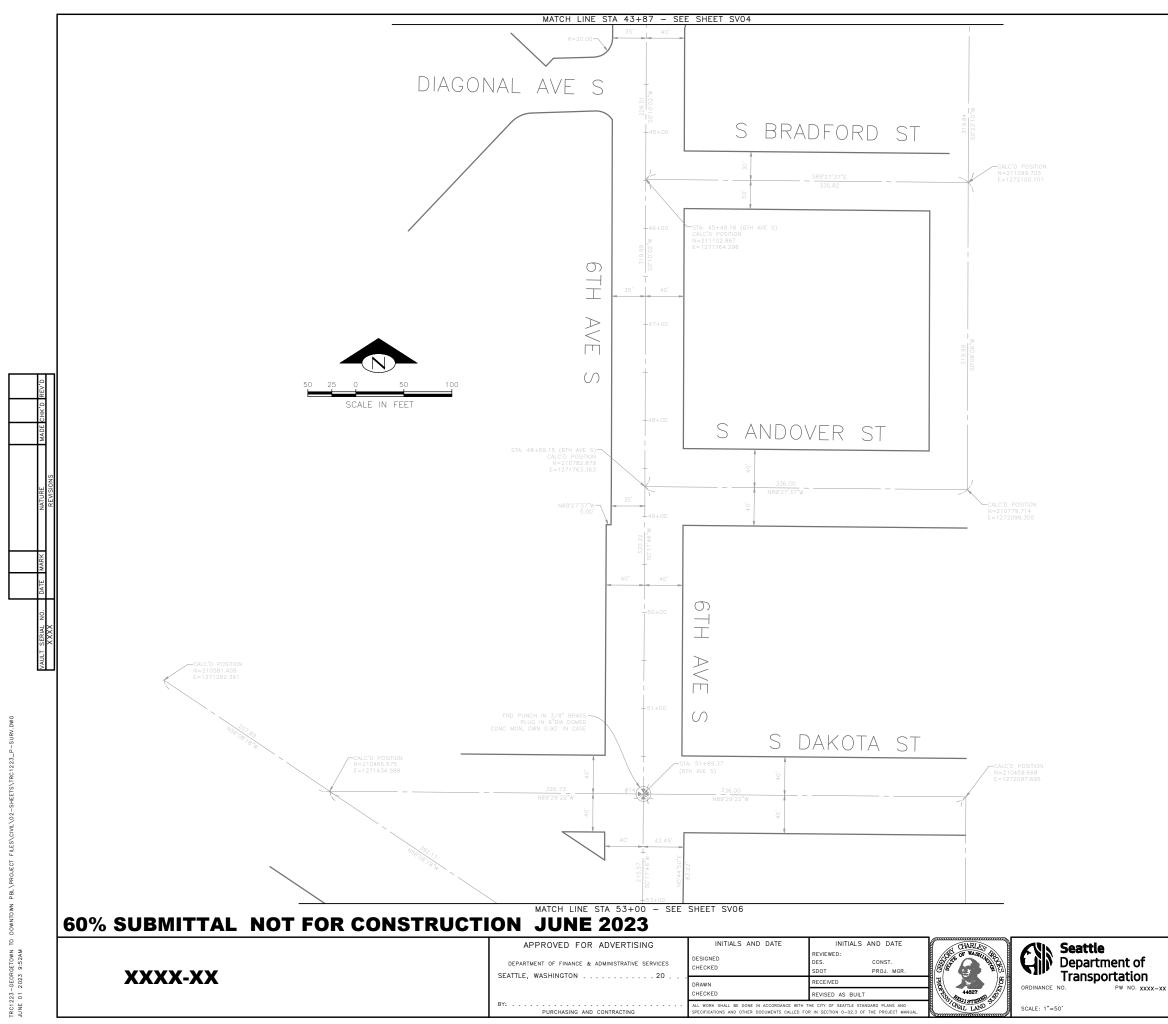

- 1 ADJUST MANHOLE, CATCH BASIN OR GAS VALVE
- 2 REMOVE CURB
- 3 ADJUST HANDHOLE
- 4 REMOVE TREE
- 5 ABANDON CATCH BASIN
- 6 REMOVE INLET
- 7 ADJUST GATE VALVE
- 8 ADJUST WATER METER
- (9) VIBRATION MONITORING. SEE SECTION 1-07.16(1)B




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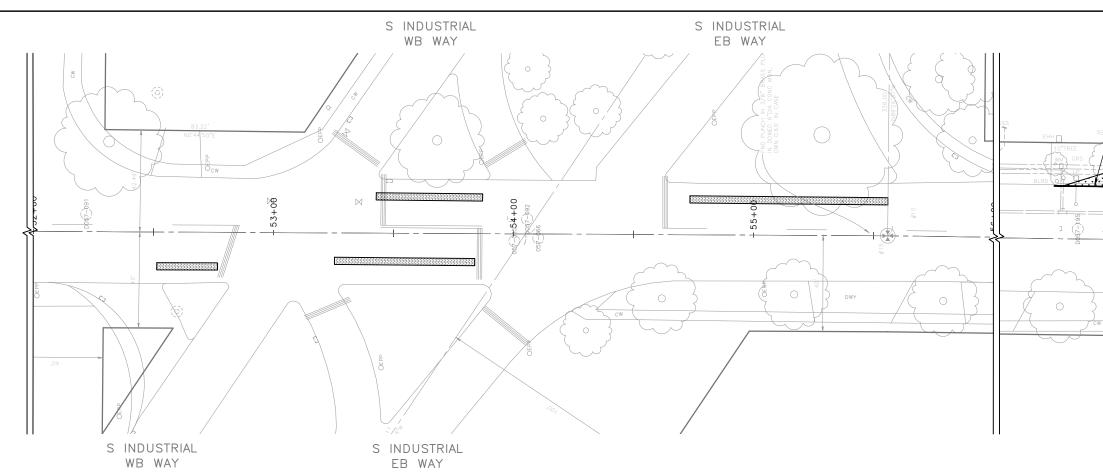
	APPROVED FOR ADVERTISING DEPARTMENT OF FINANCE & ADMINISTRATIVE SERVICES SEATTLE, WASHINGTON	INITIALS AND DATE DESIGNED CHECKED	INITIALS AND DATE REVIEWED: DES. CONST. SDOT PROJ. MGR.		Seattle Department of Transportation
PW#XXXX-XX			RECEIVED REVISED AS BUILT	51781 PERINTERED	ORDINANCE NO. PW NO. XXXX-XX
	PURCHASING AND CONTRACTING	ALL WORK SHALL BE DONE IN ACCORDANCE WITH SPECIFICATIONS AND OTHER DOCUMENTS CALLED FO	THE CITY OF SEATTLE STANDARD PLANS AND OR IN SECTION 0-02.3 OF THE PROJECT MANUAL.	STONAL WY	SCALE: 1"=20'





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		INITIALS AND DATE DESIGNED CHECKED	INITIALS AND DATE REVIEWED: DES. CONST. SDOT PROJ. MGR.		Seattle Department of Transportation
PW#XXXX-XX		DRAWN CHECKED	RECEIVED REVISED AS BUILT	51781	ORDINANCE NO. PW NO. XXXX-XX
	BY:PURCHASING AND CONTRACTING	ALL WORK SHALL BE DONE IN ACCORDANCE WITH THE CITY OF SEATLE STANDARD PLANS A TRACTING SPECIFICATIONS AND OTHER DOCUMENTS CALLED FOR IN SECTION 0-02.3 OF THE PROJECT			SCALE: 1"=20'

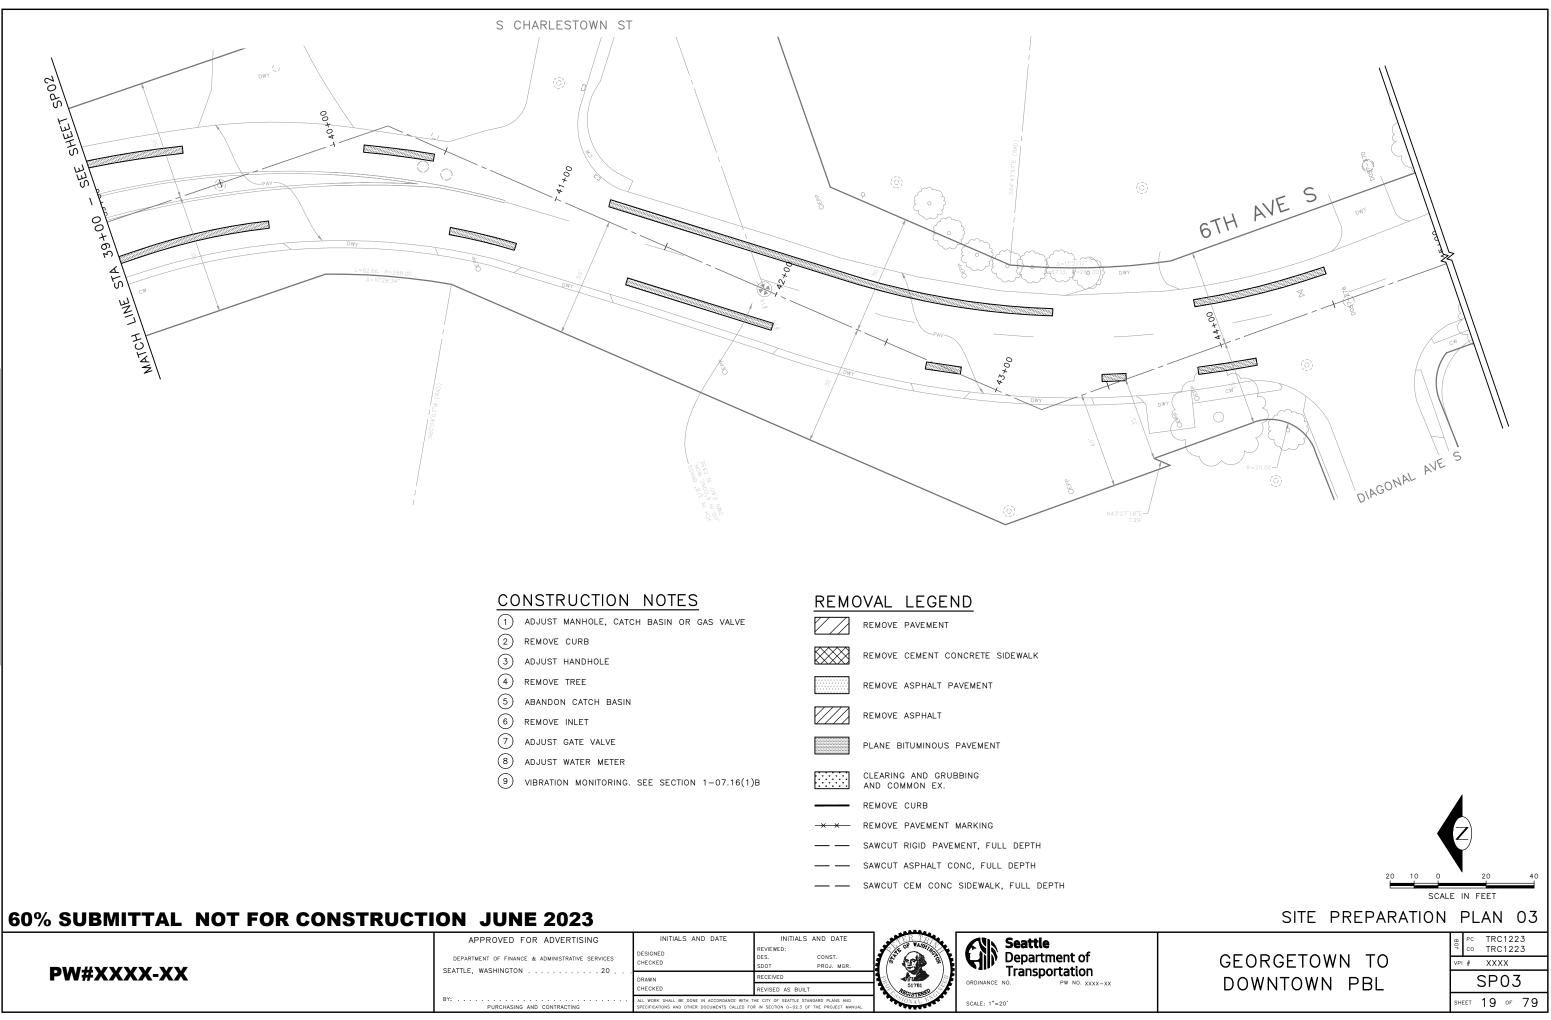

- 1) ADJUST MANHOLE, CATCH BASIN OR GAS VALVE
- 2 REMOVE CURB
- 3 ADJUST HANDHOLE
- 4 REMOVE TREE
- 5 ABANDON CATCH BASIN
- 6 REMOVE INLET
- (7) ADJUST GATE VALVE
- (8) ADJUST WATER METER
- 9 VIBRATION MONITORING. SEE SECTION 1-07.16(1)B


REMOVAL LEGEND


- REMOVE PAVEMENT
- REMOVE CEMENT CONCRETE SIDEWALK
 - REMOVE ASPHALT PAVEMENT
- REMOVE ASPHALT
 - PLANE BITUMINOUS PAVEMENT
- CLEARING AND GRUBBING AND COMMON EX.
- REMOVE CURB
- × × REMOVE PAVEMENT MARKING
- --- SAWCUT RIGID PAVEMENT, FULL DEPTH
- --- SAWCUT ASPHALT CONC, FULL DEPTH

60% SUBMITTAL NOT FOR CONSTRUCTION JUNE 2023

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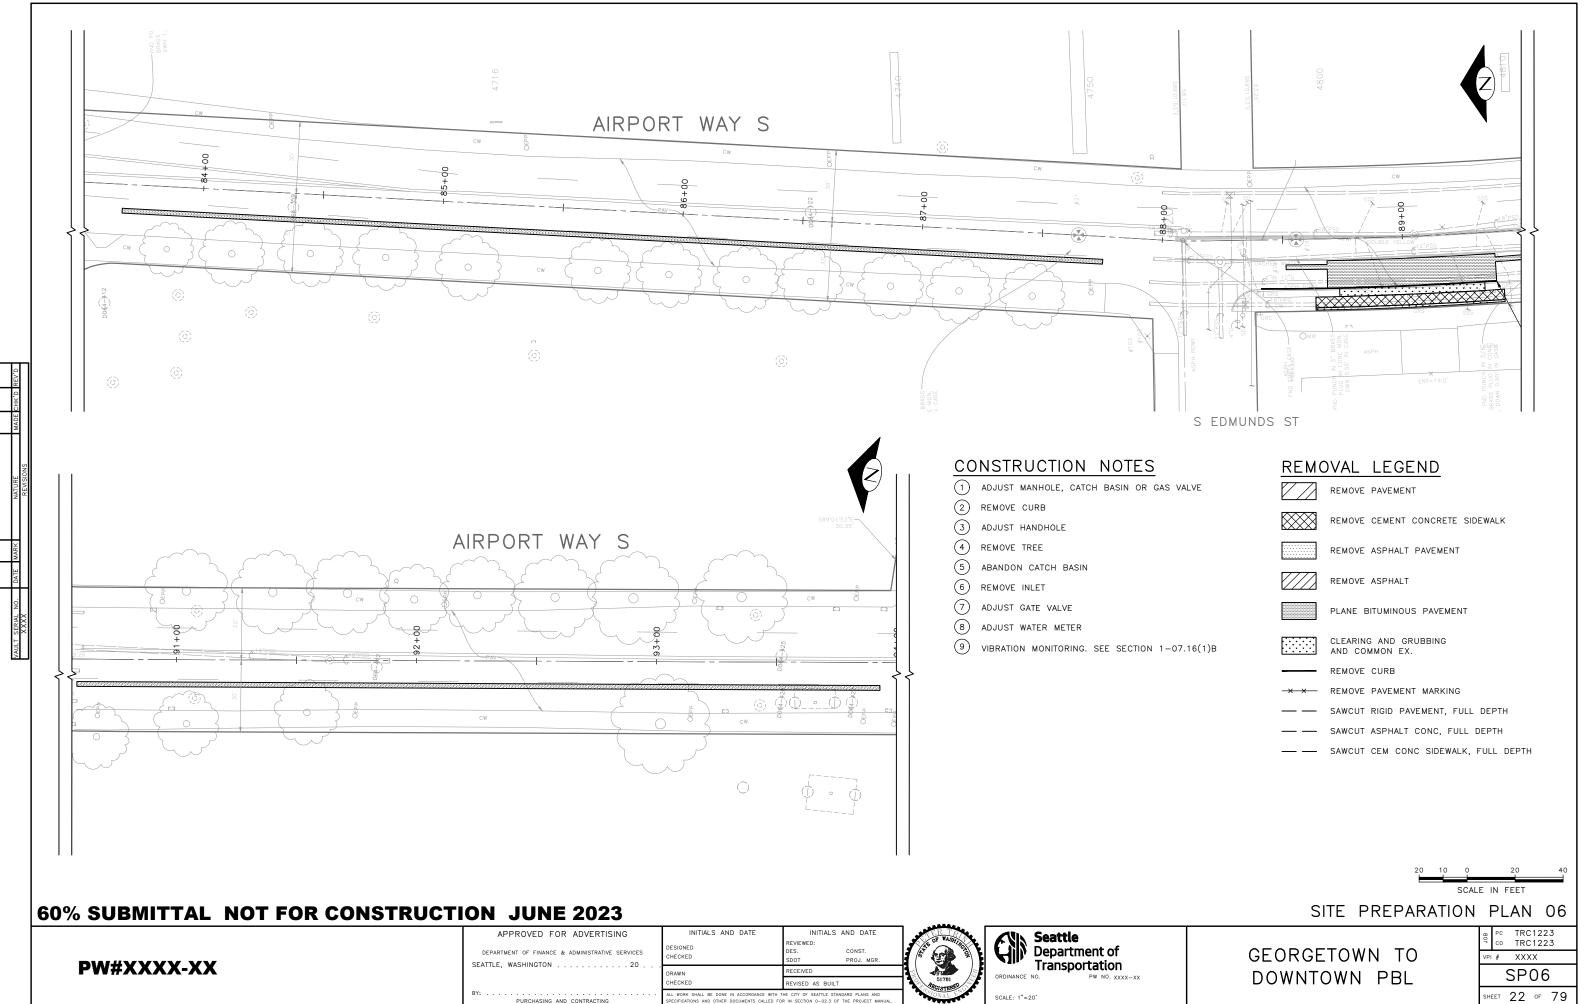
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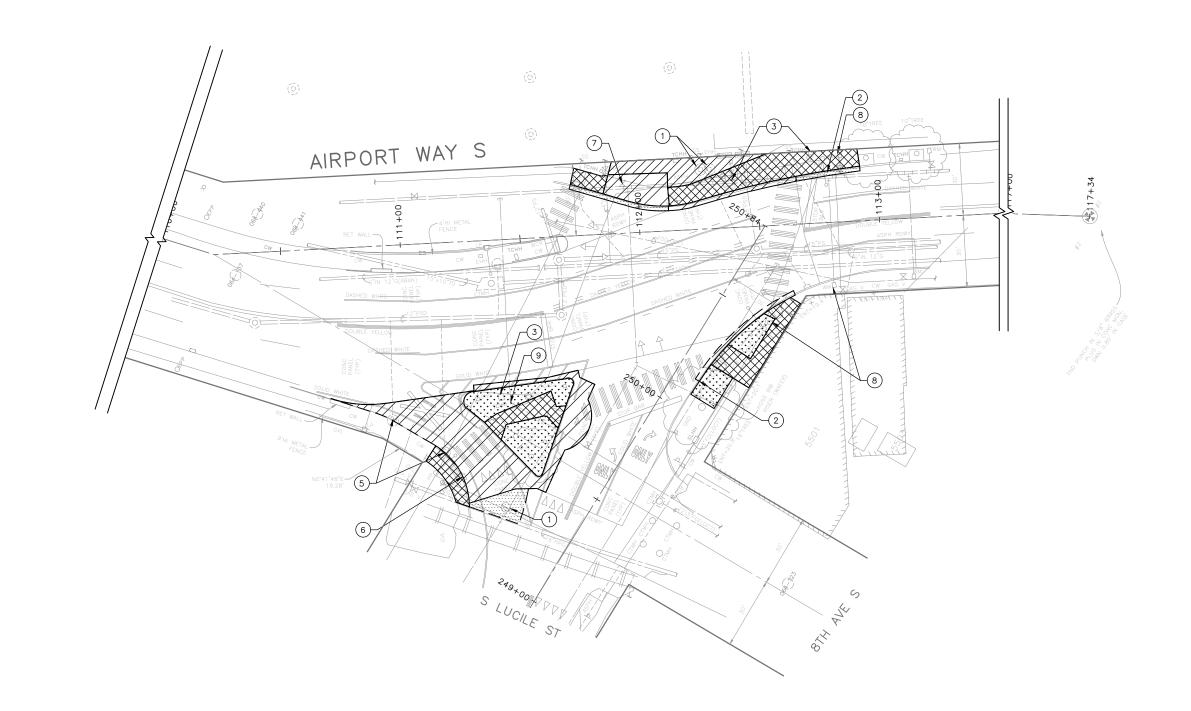
TRC1223-GEORGETOWN 1 JUNE 01 2023 9:56AM

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-XX	SEATTLE, WASHINGTON	DRAWN CHECKED	RECEIVED	51781	ORDINANCE NO. PW NO. XXXX-XX
	RY-	ALL WORK SHALL BE DONE IN ACCORDANCE WITH T	REVISED AS BUILT	ARCISTERED	
		SPECIFICATIONS AND OTHER DOCUMENTS CALLED FO		CONAL P	SCALE: 1"=20'

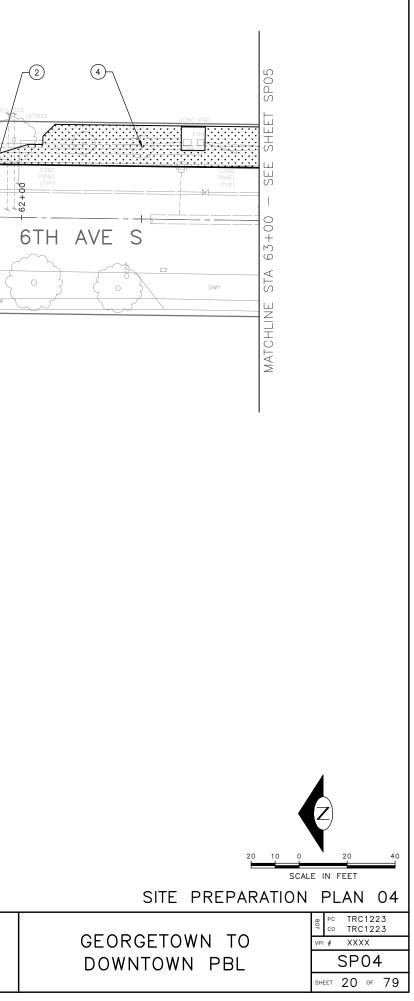
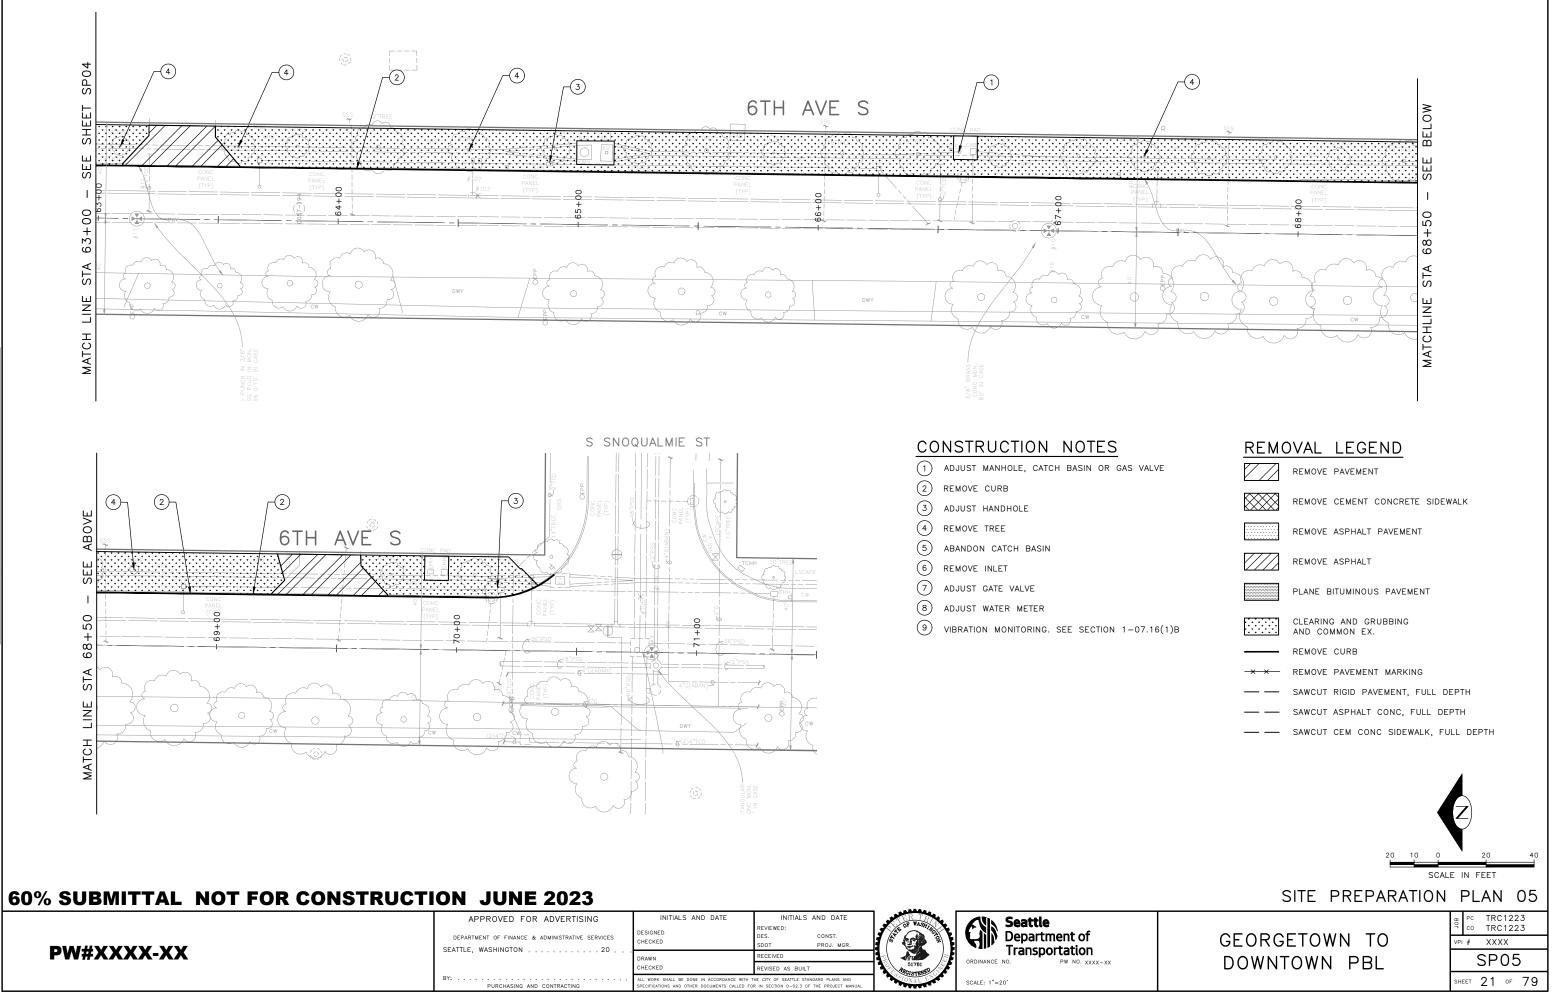
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BY:		DEPARTMENT OF FINANCE & ADMINISTRATIVE SERVICES	DESIGNED	REVIEWED: DES. CONST.		Department of
	XXX-XX	BY:	CHECKED ALL WORK SHALL BE DONE IN ACCORDANCE WITH T	REVISED AS BUILT HE CITY OF SEATTLE STANDARD PLANS AND	51781	ORDINANCE NO. PW NO. XXXX-XX



60% SUBMITTAL NOT FOR CONSTRUCTION JUNE 2023

TRC1223-GEORGETOWN JUNE 01 2023 9:57AM

	APPROVED FOR ADVERTISING DEPARTMENT OF FINANCE & ADMINISTRATIVE SERVICES	INITIALS AND DATE DESIGNED CHECKED	INITIALS AND DATE REVIEWED: DES. CONST. SDOT PROJ. MGR.		Seattle Department of
PW#XXXX-XX	BY:	DRAWN CHECKED	RECEIVED REVISED AS BUILT	51781 RECISTENEE	ORDINANCE NO. PW NO. XXXX-XX
	PURCHASING AND CONTRACTING	ALL WORK SHALL BE DONE IN ACCORDANCE WITH SPECIFICATIONS AND OTHER DOCUMENTS CALLED FO	THE CITY OF SEATTLE STANDARD PLANS AND OR IN SECTION 0-02.3 OF THE PROJECT MANUAL.	SIONAL WY	SCALE: 1"=20'


CONSTRUCTION NOTES


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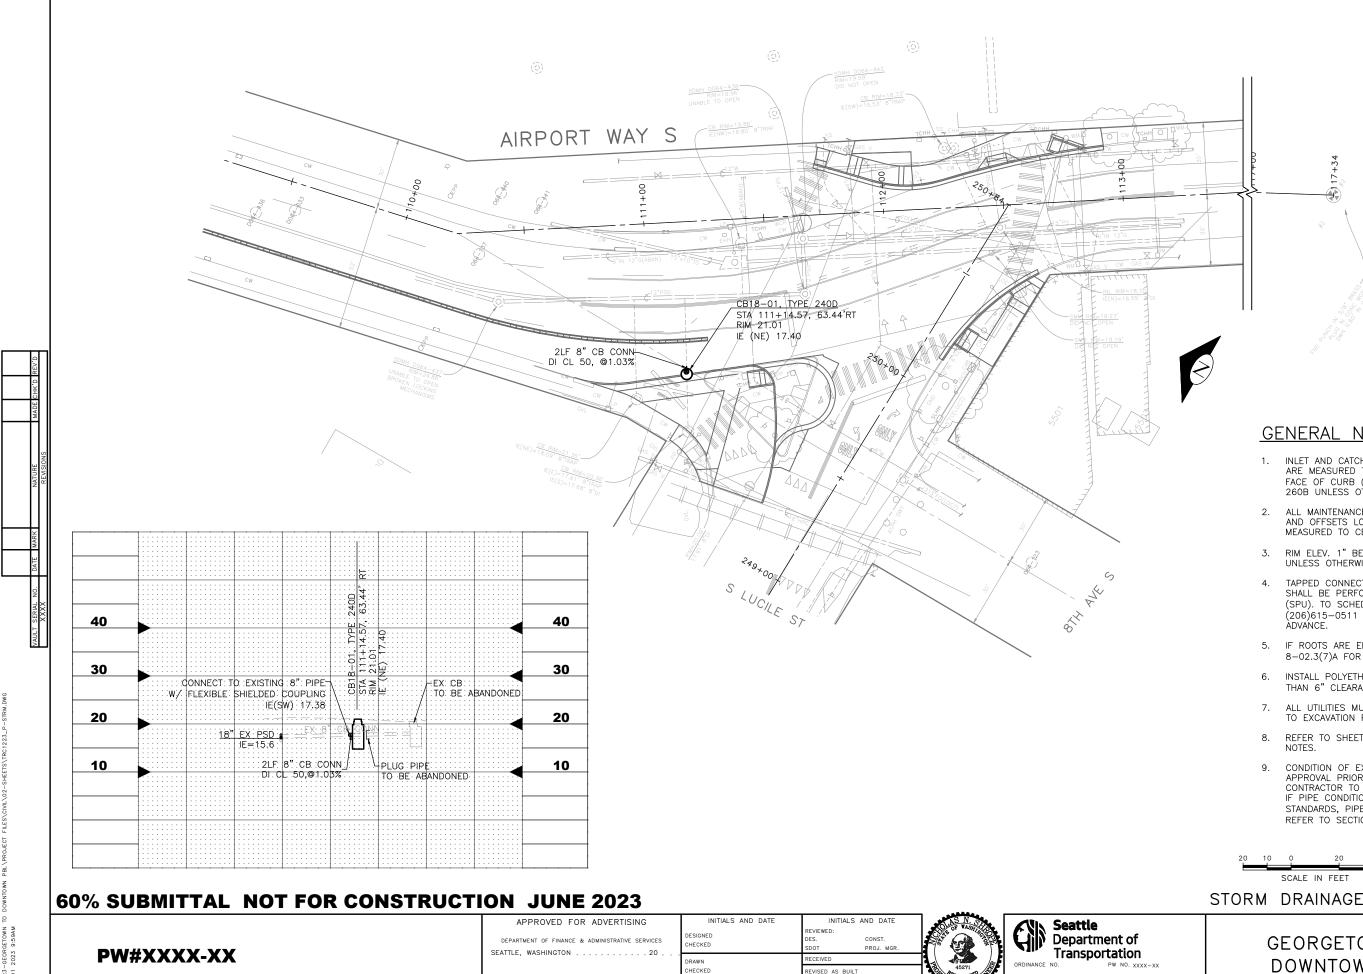
REMOVAL LEGEND

- $\overline{//}$ REMOVE PAVEMENT \bigotimes REMOVE CEMENT CONCRETE SIDEWALK
- REMOVE ASPHALT PAVEMENT
- REMOVE ASPHALT
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- CLEARING AND GRUBBING AND COMMON EX.
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XXXX-XX	SEATTLE, WASHINGTON	DRAWN CHECKED	RECEIVED REVISED AS BUILT	45271 601575550	ORDINANCE NO. PW NO. XXXX-XX	DOWNTO
	BY:	ALL WORK SHALL BE DONE IN ACCORDANCE WITH T SPECIFICATIONS AND OTHER DOCUMENTS CALLED FO	HE CITY OF SEATTLE STANDARD PLANS AND R IN SECTION 0-02.3 OF THE PROJECT MANUAL.	IONAL EN	SCALE: H. 1"=20', V. 1"=10'	



ALL WORK SHALL BE DONE IN ACCORDANCE WITH THE CITY OF SEATTLE STANDARD PLANS ANI SPECIFICATIONS AND OTHER DOCUMENTS CALLED FOR IN SECTION 0-02.3 OF THE PROJECT M
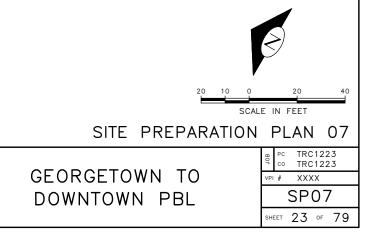
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SCALE: H. 1"=20', V. 1"=10'

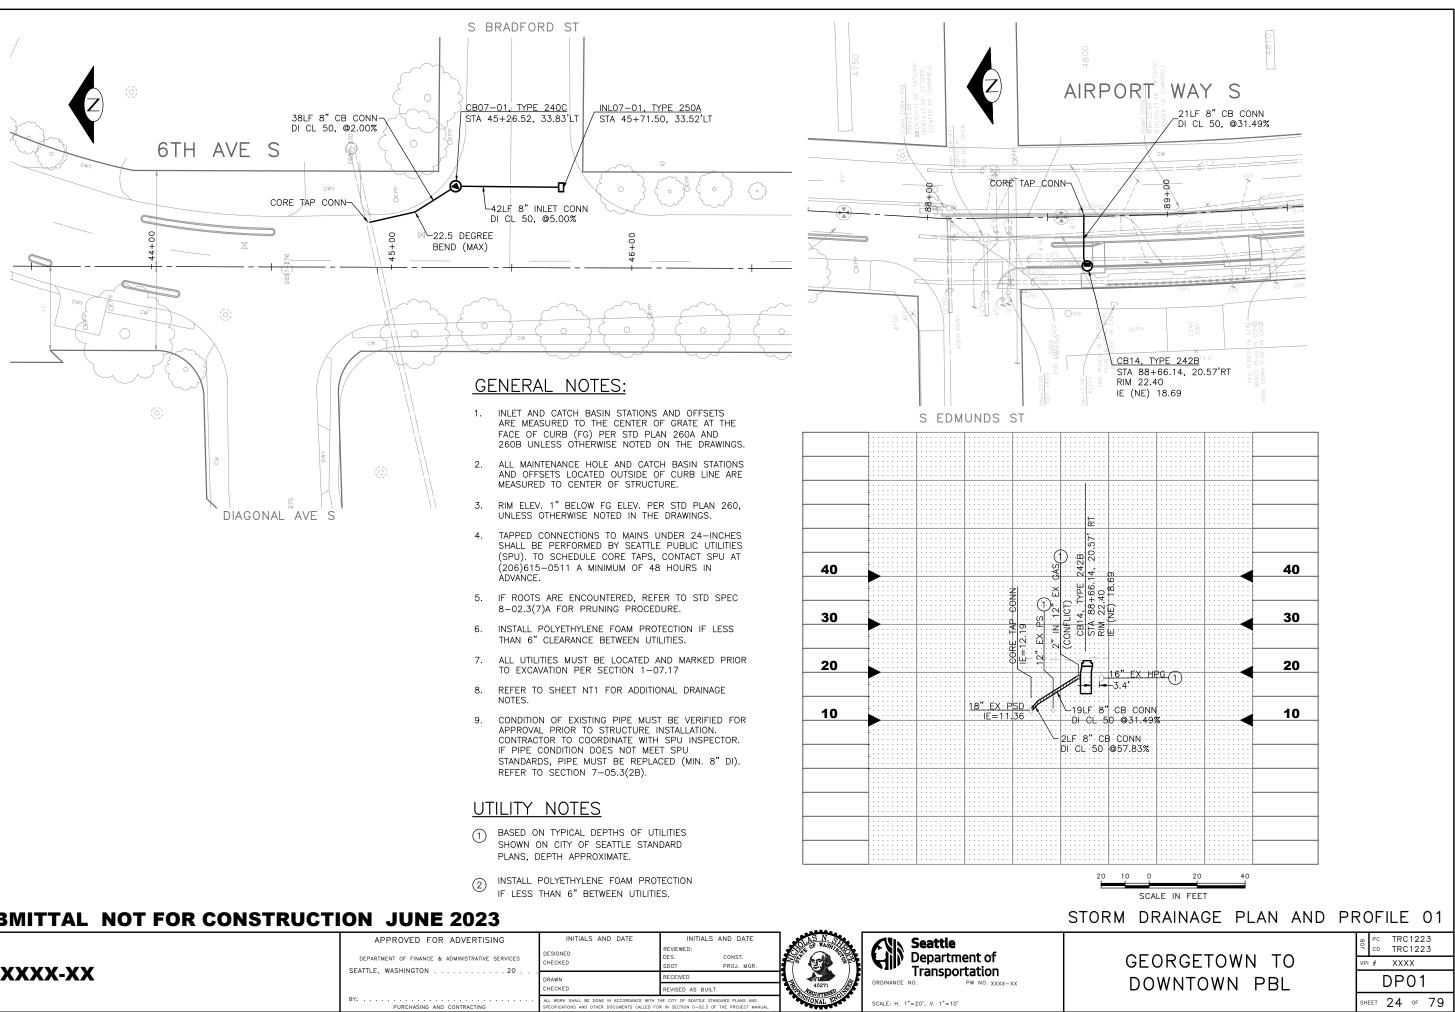GENERAL NOTES:

- 1. INLET AND CATCH BASIN STATIONS AND OFFSETS ARE MEASURED TO THE CENTER OF GRATE AT THE FACE OF CURB (FG) PER STD PLAN 260A AND 260B UNLESS OTHERWISE NOTED ON THE DRAWINGS.
- 2. ALL MAINTENANCE HOLE AND CATCH BASIN STATIONS AND OFFSETS LOCATED OUTSIDE OF CURB LINE ARE MEASURED TO CENTER OF STRUCTURE.
- 3. RIM ELEV. 1" BELOW FG ELEV. PER STD PLAN 260, UNLESS OTHERWISE NOTED IN THE DRAWINGS.
- TAPPED CONNECTIONS TO MAINS UNDER 24-INCHES SHALL BE PERFORMED BY SEATTLE PUBLIC UTILITIES (SPU). TO SCHEDULE CORE TAPS, CONTACT SPU AT (206)615-0511 A MINIMUM OF 48 HOURS IN
- 5. IF ROOTS ARE ENCOUNTERED, REFER TO STD SPEC 8-02.3(7)A FOR PRUNING PROCEDURE.
- 6. INSTALL POLYETHYLENE FOAM PROTECTION IF LESS THAN 6" CLEARANCE BETWEEN UTILITIES.
- 7. ALL UTILITIES MUST BE LOCATED AND MARKED PRIOR TO EXCAVATION PER SECTION 1-07.17
- REFER TO SHEET NT1 FOR ADDITIONAL DRAINAGE
- CONDITION OF EXISTING PIPE MUST BE VERIFIED FOR APPROVAL PRIOR TO STRUCTURE INSTALLATION. CONTRACTOR TO COORDINATE WITH SPU INSPECTOR. IF PIPE CONDITION DOES NOT MEET SPU STANDARDS, PIPE MUST BE REPLACED (MIN. 8" DI). REFER TO SECTION 7-05.3(2B).

STORM DRAINAGE PLAN AND PROFILE 02

GEORGETOWN	ТО
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TRAFFIC SIGNAL LEGEND:

- EMERGENCY VEHICLE DETECTOR (EVD)
- VIDEO DETECTION CAMERA, FISH EYE
- VIDEO DETECTION CAMERA

ABBREVIATIONS:

- APS ACCESSIBLE PEDESTRIAN SIGNAL
- EVD EMERGENCY VEHICLE DETECTOR VD VIDEO DETECTOR
- LED LIGHT EMITTING DIODE
- SVC SERVICE SIT SEATTLE INFORMATION TECHNOLOGY

TRAFFIC SIGNAL CABINET/CONTROLLER UPGRADE

NO.	INTERSECTION	SIGNAL CONTROLLER
1	AIRPORT WY S/ S LUCILE ST	
2	6TH AVE S/S SPOKANE ST	х
3	6TH AVE S/S FOREST ST	х

CONTRACTOR TO COORDINATE WITH SDOT SIGNAL SHOP FOR PICK-UP PRIOR TO CONTRACTOR INSTALL

SIGNAL NOTE:

- 1. THE CONTRACTOR MUST IMMEDIATELY REPORT ANY DAMAGE TO THE TRAFFIC SIGNAL SYSTEM, INCLUDING CONDUIT AND THE DETECTOR LOOPS. SEE SECTION $1\!-\!07.28$ NOTE 16.
- THE TRAFFIC SIGNAL SYSTEM INTERCONNECT CABLE AND SIGNAL WIRE SERVICE, VIDEO, OR MASTER CABLE MUST NOT BE SPLICED. SEE SECTIONS 8-31.3(8)A AND 8-31.3(9)B.
- 3. THE CONTRACTOR MUST CONTACT SDOT TRAFFIC SIGNAL OPERATIONS WHEN THE TRAFFIC SIGNAL SYSTEMS OR THE TRAFFIC DETECTOR LOOPS MAY BE IMPACTED BY CONSTRUCTION. ADVANCE NOTIFICATION IS REQUIRED. SEE SECTION 1-07.28, SIGNALIZED INTERSECTIONS.
- 4. THE CONTRACTOR MUST PROVIDE PRELIMINARY LAYOUT FOR THE TRAFFIC DETECTION. THE LAYOUT MUST BE VERIFIED BY THE ENGINEER PRIOR TO SAW CUTTING. ADVANCE NOTIFICATION IS REQUIRED. SEE SECTION 8-31.3(5)A.
- 5. FINAL POLE AND CABINET LOCATIONS MUST BE FIELD VERIFIED BY THE ENGINEER PRIOR TO EXCAVATION.
- 6. CONTRACTOR MUST INVESTIGATE FOR UNDERGROUND UTILITIES PRIOR TO ANY FOUNDATION EXCAVATION OR CONDUIT TRENCHING TO AVOID DAMAGE TO ANY UNDERGROUND UTILITIES (INCLUDING SIDE SEWERS). ANY CONFLICTS MUST BE BROUGHT TO THE ATTENTION OF THE ENGINEER PRIOR TO ANY CONSTRUCTION WORK.
- CONTRACTOR MUST VERIFY THE CAPACITIES OF ALL EXISTING CONDUITS DESIGNATED FOR USE ON THIS PROJECT. ANY DISCREPANCIES MUST BE BROUGHT TO THE ATTENTION OF THE ENGINEER PRIOR TO ANY CONSTRUCTION WORK.
- CONTRACTOR MUST COORDINATE WITH SDOT/SCL/SDCI INSPECTOR AT THE START OF CONSTRUCTION FOR INSPECTION REQUIREMENT AT VARIOUS STAGES OF CONSTRUCTION AS INSTRUCTED BY THE INSPECTOR AND PROVIDE ASSISTANCE AS NECESSARY.
- 9. CONTRACTOR MUST COMBINE TRAFFIC, LIGHTING AND ITS CONDUITS IN THE SAME TRENCH WHERE FEASIBLE.
- 11. ALL DISCONNECTIONS, TEMPORARY CONNECTIONS AND FINAL SERVICE CONNECTIONS WILL BE MADE BY SEATTLE CITY LIGHT (SCL).
- 12. COMPLY WITH OSHA AND WAC FOR WORK NEAR OVERHEAD POWER. COORDINATE WITH SCL FOR OVERHEAD UTILITY CLEARANCE AND WORKING UNDER OVERHEAD UTILITIES.
- 13. HAND DIGGING OR EXCAVATION BY VACTOR MAY BE REQUIRED IN AREAS WHERE UNDERGROUND UTILITIES CONFLICT WITH FOUNDATION AND/OR CONDUIT INSTALLATION. FOR TREE ROOTS CONFLICT, HAND DIGGING OR PNUEMATIC AIR EXCAVATION MAY BE REQUIRED.
- 14. EQUIPMENT AND MACHINERY WITH METAL IN IT MUST BE PROPERLY GROUNDED.
- 15. COORDINATE WITH SEATTLE IT FOR FIBER LOCATES IN THE AREA PRIOR TO EXCAVATION.


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	DEPARTMENT OF FINANCE & ADMINISTRATIVE SERVICES	DESIGNED CHECKED	REVIEWED: DES. CONST. SDOT PROJ. MGR.		Department of
PW#XXXX-XX	SEATTLE, WASHINGTON	DRAWN	RECEIVED	49491	ORDINANCE NO. PW NO. XXXX->
	PV.		REVISED AS BUILT	ABCISTERED CIT	
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LIGHTING NOTE:

- ALL DISCONNECTIONS, TEMPORARY OR FINAL SERVICE CONNECTIONS WILL BE MADE BY SEATTLE CITY LIGHT (SCL) AT PROJECT'S EXPENSE. COORDINATE ALL ENERGIZING AND DE-ENERGIZING OF STREET LIGHTING SERVICE WITH SCL ELECTRICAL SERVICE REPRESENTATIVE AND STREETLIGHT ENGINEER FIFTEEN (15) WORKING DAYS IN ADVANCE. ADDITIONAL TIME MAY BE NEEDED FOR CREW SCHEDULING AND MOBILIZATION.
- 2. CONTRACTOR MUST MAKE PRIOR COORDINATION FOR FLOOD OR STREETLIGHT REMOVAL. CONTRACTOR MUST MAKE PRIOR DELIVERY COORDINATION FOR SALVAGED STREETLIGHT-RELATED MATERIALS TO SEATTLE CITY LIGHT SALVAGE YARD AT 4TH AVE S & S SPOKANE ST, 98134. CONTACT SALVAGE COORDINATOR AT 206-386-1765. NO ARTERIAL STREETLIGHT MAY BE DISABLED WITHOUT PRIOR APPROVAL FROM SEATTLE DEPARTMENT OF TRANSPORTATION (SDOT).
- 3. EXISTING STREET LIGHTING SYSTEM SHALL BE MAINTAINED DURING CONSTRUCTION.
- 4. WORK MUST BE SCHEDULED SUCH THAT NO TWO (2) ADJACENT OR OPPOSITE STREETLIGHTS ARE DISABLED AT ANY ONE TIME.
- ANY EXCAVATION IN PROXIMITY TO AN EXISTING STREETLIGHT POLE MUST BE DONE WITHOUT UNDERMINING ITS STABILITY. CONTRACTOR IS RESPONSIBLE FOR TEMPORARY STABILIZING SUPPORT.
- 6. ALL SCL WORK SHALL CONFORM TO SEATTLE CITY LIGHT (SCL) STANDARDS.
- INSTALLATION OF UNDERGROUND STREETLIGHT SYSTEMS, AND STREETLIGHT SYSTEM GROUNDING AND BONDING MUST BE PER SEATTLE CITY LIGHT (SCL) CONSTRUCTION STANDARD 1714.50.
- ALL WIRING, INCLUDING STREET LIGHTING, PEDESTRIAN LIGHTING AND FESTOON LIGHTING CIRCUITS MUST BE CLEARLY LABELED PER SEATTLE CITY LIGHT (SCL) CONSTRUCTION STANDARD 1714.10.
- 9. EACH LUMINAIRE MUST BE FUSED PER (SCL) CONSTRUCTION STANDARD 1730.00.
- 10. STREETLIGHT HANDHOLE AND CONDUIT REQUIREMENTS MUST CONFORM TO SCL CONSTRUCTION STANDARD 1716.07.
- 11. PULL TAPE MUST BE INSTALLED THROUGH VACANT CONDUIT AND CAPPED PER (SCL) CONSTRUCTION STANDARD U2-11.40/NDK-40.
- 12. MAINTAIN MINIMUM HORIZONTAL & VERTICAL CLEARANCES BETWEEN SCL UNDERGROUND STRUCTURES AND VARIOUS OTHER UTILITY STRUCTURES PER SCL CONSTRUCTION STANDARD 0214.00.
- 13. FOR STREET LIGHTING INSPECTIONS CONTACT SCL ELECTRICAL REVIEWER FIFTEEN (15) WORKING DAYS IN ADVANCE.
- 14. CONTRACTOR MUST CALL FOR AN ELECTRICAL REVIEWER INSPECTION OF THE STREET LIGHTING SYSTEM AT VARIOUS STAGES OF INSTALLATION/CONSTRUCTION OR AS INSTRUCTED BY THE SCL INSPECTOR.
- 15. CONTRACTOR MUST PROVIDE AN OPERATOR AND MAN LIFT TRUCK FOR USE DURING INSPECTION OF INSTALLED STREETLIGHT FACILITIES.
- 16. CONTRACTOR MUST ASSIST THE INSPECTOR DURING INSPECTIONS, COMMISSIONING, AND FINAL CONNECTION PHASES OF THE PROJECT AS INSTRUCTED BY THE INSPECTOR. SUCH ASSISTANCE WILL INCLUDE, BUT NOT BE LIMITED TO OPENING HANDHOLES, MANHOLES AND VARIOUS ACCESS COVERS, DISCONNECTING AND RECONNECTING FUSE HOLDERS AND MECHANICAL SPLICE CONNECTIONS, VERIFYING CONDUIT RUNS, ETC.
- 17. PRIOR TO REQUESTING FINAL STREETLIGHT SERVICE CONNECTION, CONTRACTOR MUST CORRECT ALL PUNCH LIST ITEMS AND CALL FOR A RE-INSPECTION WHERE REQUIRED BY THE INSPECTOR. CONTRACTOR MUST PREPARE A SIGNED AS-BUILT AND WIRING DIAGRAM WHICH INCLUDES WHICH DUCT IS USED IN EACH DUCT BANK.

SI	GNAL	LEGEND	ABBREVIATIONS	A	ND	NOTES
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		GEORG	ETOWN TO		VPI #	XXXX
				SG01		
					SHEET	26 of 79



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-GEORGETOWN 2023 2:32PM
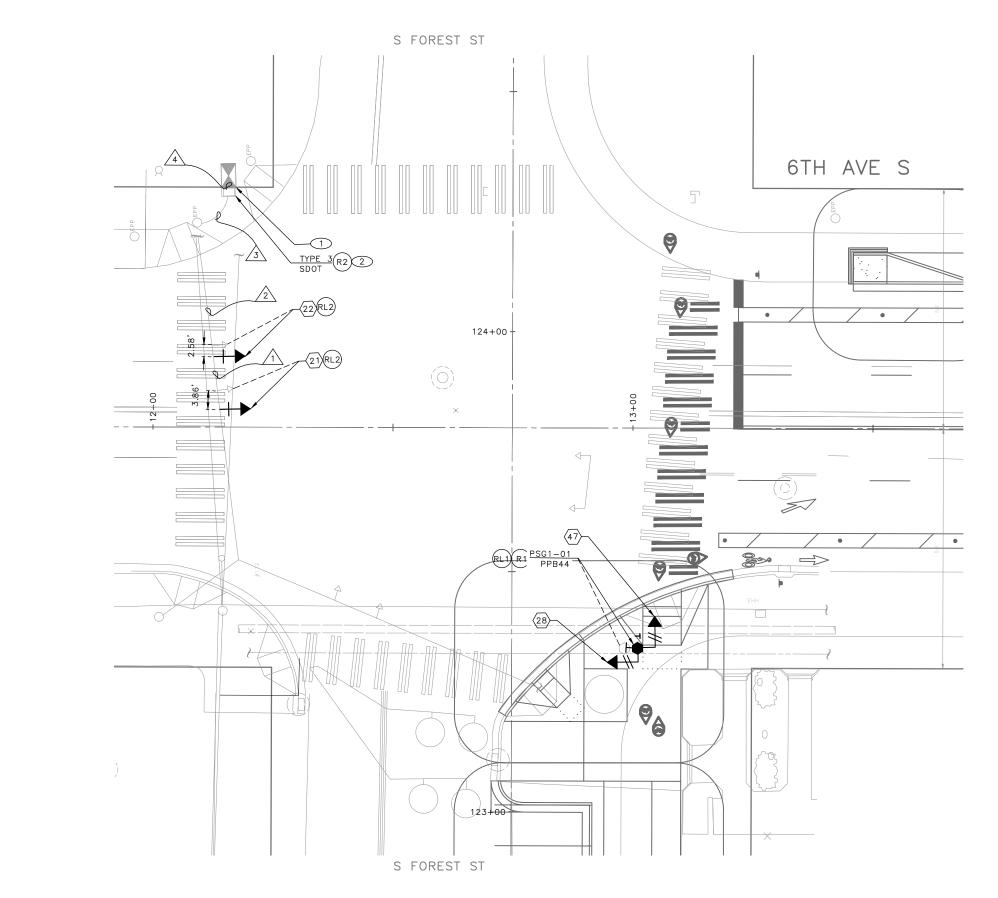
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PW#XXXX-XX	APPROVED FOR ADVERTISING DEPARTMENT OF FINANCE & ADMINISTRATIVE SERVICES SEATTLE, WASHINGTON	INITIALS AND DATE DESIGNED CHECKED DRAWN CHECKED	INITIALS AND DATE REVIEWED: DES. CONST. SDOT PROJ. MGR. RECEIVED REVISED AS BUILT	49491	Seattle Department of Transportation
	BY:	ALL WORK SHALL BE DONE IN ACCORDANCE WITH SPECIFICATIONS AND OTHER DOCUMENTS CALLED FO	THE CITY OF SEATTLE STANDARD PLANS AND	And ISTERE	SCALE: AS NOTED

CONSTRUCTION NOTES INSTALL:



(1) CONTROLLER INSTALLED IN EX TRAFFIC SIGNAL CABINET BY OTHERS. COORDINATE INSTALLATION THRU THE ENGINEER.

2 NEW HANDHOLE. TYPE SHOWN ON DRAWINGS. MAINTAIN AND PROTECT EX CONDUCTORS.

REMOVE/RELOCATE:

- REMOVE EX PEDESTAL FOUNDATION (R1)
- REMOVE EX HANDHOLE TO UPDATE LID TO CURRENT STANDARD. PROTECT AND MAINTAIN EX CONDUCTORS. REF TO WIRING SCHEDULE (R2)
- RELOCATE EX PEDESTAL POLE WITH ATTACHED WEATHERHEAD, PED HEAD AND PUSHBUTTON. REF TO PUSHBUTTON SCHEDULE. RL1
- TO MATCH NEW CHANNELIZATION, RELOCATE EX SIGNAL HEADS ON EX SPAN AS SHOWN ON THE DRAWINGS. REWIRE HEADS. REFER TO WIRING SCHEDULE RL2

SIGNAL HEAD DISPLAY










SPAN MOUNTED

EXISTING PHASE DIAGRAM

5 6 7 8 NOT NOT NOT NOT USED USED USED USED	1 NOT USED	2	3 NOT USED	4> >
	NOT	NOT		NOT

PEDESTRIAN <---->

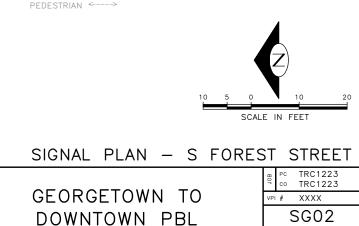

SHEET 27 OF 79

WIRING SCHEDULE

RUN NO	SPAN OR CONDUIT SIZE	EXISTING CONDUCTORS	VEHICLE HEAD	GROUND	COMMENTS
1	SPAN		1-5C	#6	
2	SPAN		2-5C	#6	
3	EX 3"		2-5C	#6	
4	EX 3"		2-5C	#6	

	POLE/PEDESTAL SCHEDULE									
POLE NO.	STATION/LOCATION AND OFFSET	POLE TYPE	LENGTH (FT)	FOUNDATION TYPE	MAST ARM LENGTH (FT)	LUMINAIRE ARM LENGTH (FT)	LUMINAIRE WATTAGE	LUMINAIRE MOUNTING HEIGHT (FT)		
P1	XX+XX.XX, XX.XX	EX PEDESTAL	EX	524B	-	-	_	-		

PPB/BPP	POLE			PEDESTRIAN SIGNALS			
	NO.	AZIMUTH CLOCKWISE)*	PHASE	SIGN	ARROW DIRECTION LOOKING AT PUSHBUTTON	NOTES	
PPB44	P1	180	4	R10-3 LEFT		ROTATE ON POLE	



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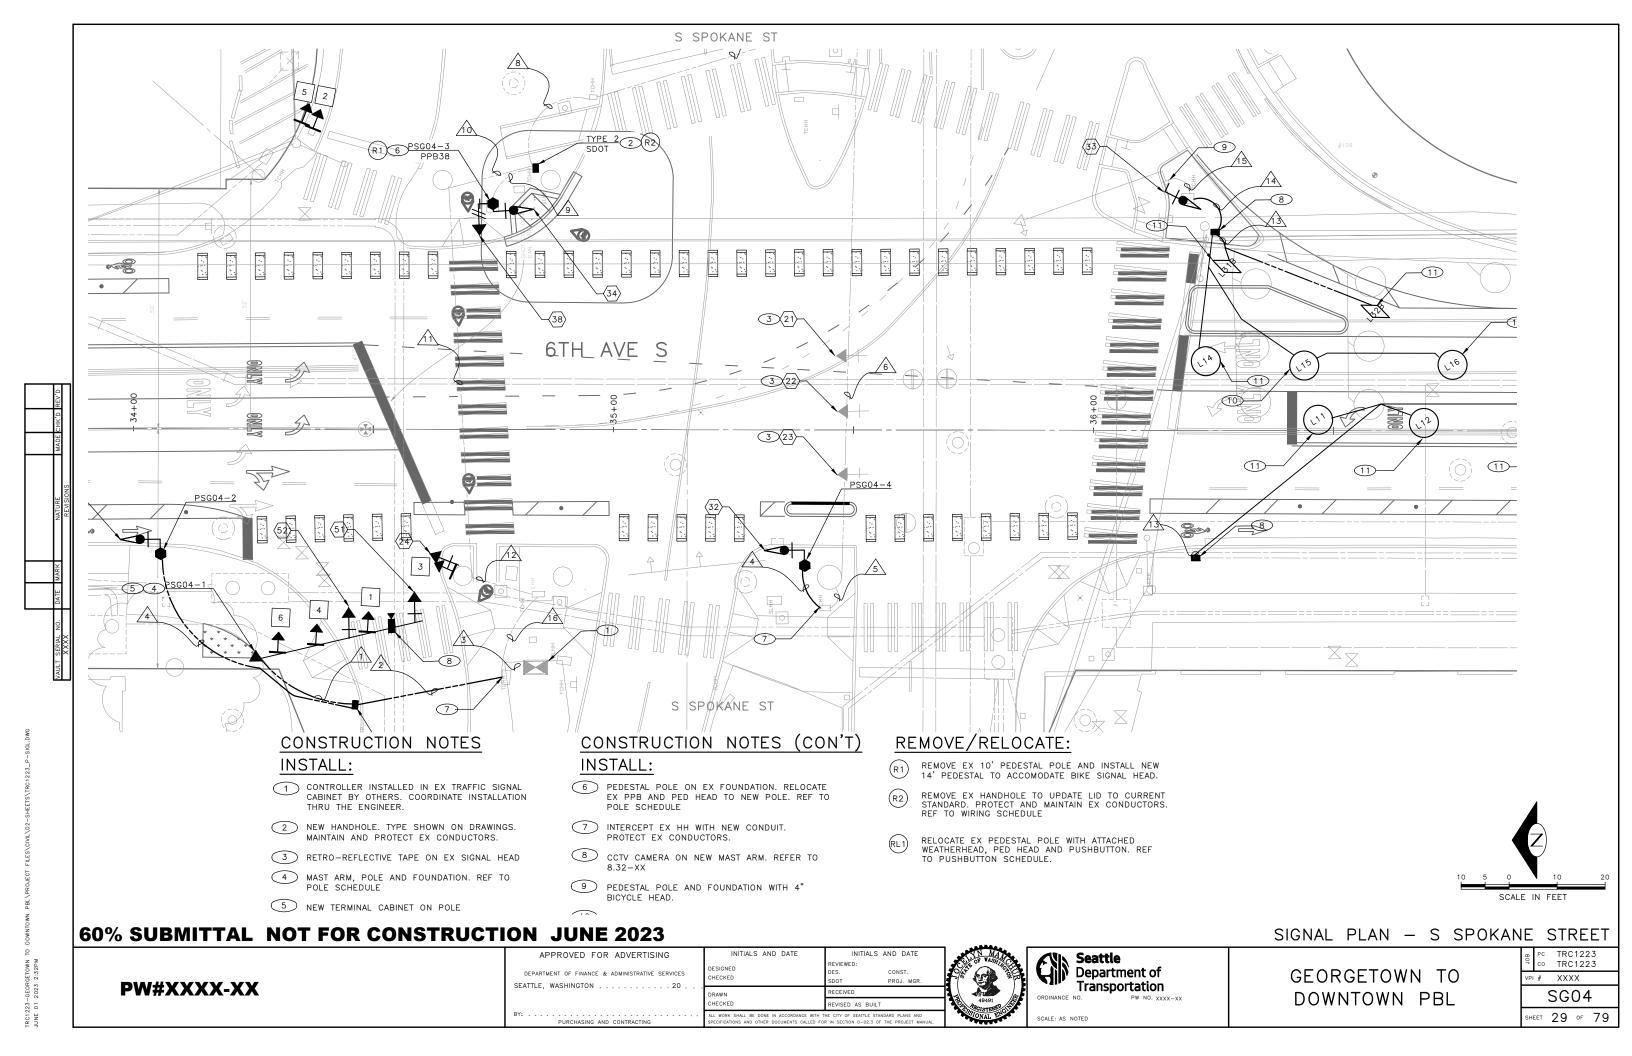
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SIG

PPB PUSHBUTTON MOUNTING SCHEDULE

0° AZIMUTH = NORTHBOUND

GNAL	. PLAN	_	S	FOREST	STREET	S	С⊦	IED	UL	ES
				GETOWN			WPI #	=== TR # XX	.,.,,	3
	DOWNTOWN PBL				SHEE	SG 28				




WIRING SCHEDULE EXISTING PHASE DIAGRAM RUN NO $1 \wedge 2 \wedge 1 \quad 3 \leftarrow -- \rightarrow 4$ SPAN OR EXISTING LOOP LOOP \triangle CONDUIT SIZE CONDUCTORS LEAD-IN

- -

	$\xrightarrow{\longrightarrow}$	USED
5 6	7	8
NOT NOT	NOT	NOT
USED USED	USED	USED

PROPOSED PHASE DIAGRAM

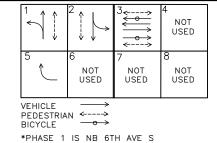

1	1-3" SDOT 1-2" SDOT	-	-	-	-	-	-	#6	SPARE
2	2-3" SDOT						1-10C, 1-5C	#6	
3	3" SDOT				1PR(SH)	1-3C	1-5C	#6	CONNECT INTO TRAFFIC SIGNAL CABINET
4	2"RGS						1-5C	#6	
5	EX RISER						1-5C	#6	
6	EX RGS ON BRIDGE DECK						1-5C	#6	
7	EX RISER						1-5C	#6	
8	EX 2"						1-5C	#6	
9	EX 2"	1-PR(SH), 1-3C			1PR(SH)	1-3C	1-5C	#6	
10	EX RISER				1PR(SH)	1-3C	1-5C	#6	
11	EX RGS ON BRIDGE DECK				1PR(SH)	1-3C	1-5C	#6	
12	EX RISER				1PR(SH)	1-3C	2-5C	#6	
13	2-2" SDOT			8-PR				#6	
14	2-2" SDOT		6-2C					#6	
15	EX 3"						2-5C	#6	
16	EX 3"							#6	
17	EX 3"		6-2C		1PR(SH)	1-3C	1-10C, 4-5C	#6	

PPB

1-PR(SH)

PED

HEADS

VEHICLE/BIKE

HEAD

GROUND

COMMENTS

POLE NO. "PSG04-"

1 2

3

4

PPB/BPP

NO.

PPB38

Ň

LOOP

L11

L12

L13

L14

L15

L16

L31B

L32B

35+4

SIGNAL HEAD DISPLAY

Y G

12"


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EXISTING

SIDE MOUNTED

R

12"

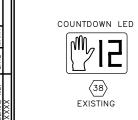


SETOWN 2:33PM

GE 0R

223

IRC12

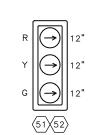

MAST ARM

MOUNTED

R Y G


12"

23 EXISTING


SIDE MOUNTED

12"

 $\langle 22 \rangle$ EXISTING

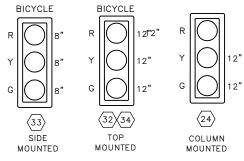

6 th Ave S 18"	
72"	
6	
18"X72"	
MAST ARM MOUNTED SDS "6TH AVE S"	

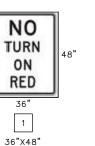

MAST ARM MOUNTED "NO TURN ON RED"



NO. XXXX-XX

SIDE MOUNTED **60% SUBMITTAL NOT FOR CONSTRUCTION JUNE 2023** APPROVE

BICYCLE

 $\langle 31 \rangle$

SIDE

MOUNTED

APPROVED FOR ADVERTISING DEPARTMENT OF FINANCE & ADMINISTRATIVE SERVICES SEATTLE, WASHINGTON	INITIALS AND DATE DESIGNED CHECKED	INITIALS AND DATE REVIEWED: DES. CONST. SDOT PROJ. MGR.		Seattle Department of
SEATTLE, WASHINGTON	DRAWN CHECKED	RECEIVED REVISED AS BUILT	49491 49491	ORDINANCE NO. PW NO. XXXX-
BY:	ALL WORK SHALL BE DONE IN ACCORDANCE WITH T SPECIFICATIONS AND OTHER DOCUMENTS CALLED FO		SIONAL ENGL	SCALE: AS NOTED

POLE/PEDESTAL SCHEDULE							
STATION/LOCATION AND OFFSET	POLE TYPE	LENGTH (FT)	FOUNDATION TYPE	MAST ARM LENGTH (FT)	LUMINAIRE ARM LENGTH (FT)	LUMINAIRE WATTAGE	LUMINAIRE MOUNTING HEIGHT (FT)
34+25.7, 47.9' RT	MAST ARM POLE	33.5	PER DETAIL	35	10.0	195/LED	35.0
34+05.6, 26'RT	PEDESTAL	10	STD PLAN NO. 524	-	I	-	-
34+75, 46.9' LT	STEEL PEDESTAL	14	STD PLAN NO. 524	-	I	-	-
35+49.9, 28.28' RT	STEEL PEDESTAL	14	STD PLAN 524				

PPB PUSHBUTTON MOUNTING SCHEDULE


POLE	LOCATION (0°		PEDESTRIAN SIGNALS				
NO.	AZIMUTH CLOCKWISE)*	PHASE	SIGN	ARROW DIRECTION LOOKING AT PUSHBUTTON	NOTES		
P2	0	3	R10-3	RIGHT	ROTATE ON POLE		


0° AZIMUTH = NORTHBOUND


LOOP SCHEDULE


STATION/LOCATION AND OFFSET	PHASE	NO. OF TURNS	ТҮРЕ	INDUCTANCE	NOTES
XX+XX.XX, XX.XX	1	4			
XX+XX.XX, XX.XX	1	4			
XX+XX.XX, XX.XX	1	4			
XX+XX.XX, XX.XX	1	4			
XX+XX.XX, XX.XX	1	4			
XX+XX.XX, XX.XX	1	4			
XX+XX.XX, XX.XX	3	_	PARALLELOGRAM		
XX+XX.XX, XX.XX	3	_	PARALLELOGRAM		


SIGNS

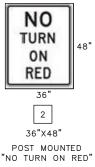


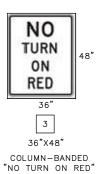

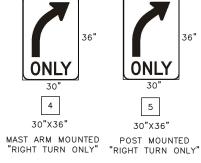

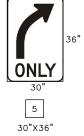

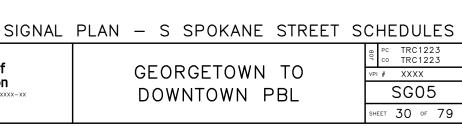

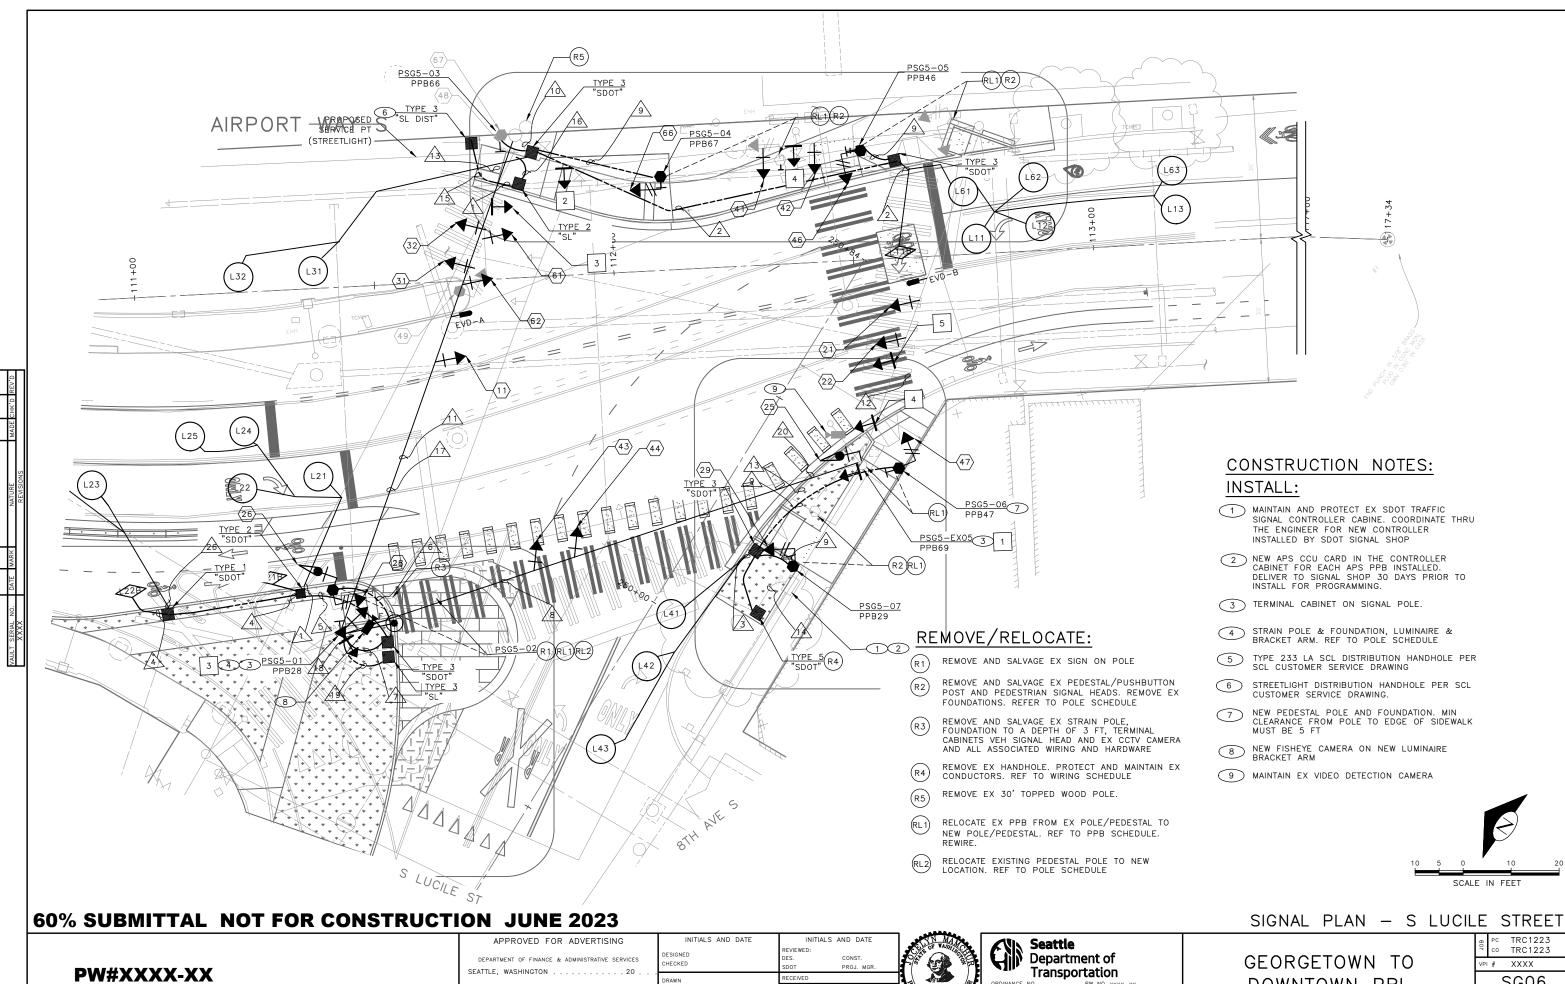

SEATTLE, WASHINGTON		SDOT
SEATTLE, WASHINGTON	DRAWN	RECEIVED
	CHECKED	REVISED AS BUILT
BY:	ALL WORK SHALL BE DONE IN ACCORDANCE WITH T	

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HE CITY OF SEATTLE STANDARD PLANS AN R IN SECTION 0-02.3 OF THE PROJECT M

RDINANCE NO. SCALE: AS NOTED

Transportation

PW NO. XXXX-XX

1	MAINTAIN AND PROTECT EX SDOT TRAFFIC SIGNAL CONTROLLER CABINE. COORDINATE THRU THE ENGINEER FOR NEW CONTROLLER INSTALLED BY SDOT SIGNAL SHOP
2	NEW APS CCU CARD IN THE CONTROLLER CABINET FOR EACH APS PPB INSTALLED. DELIVER TO SIGNAL SHOP 30 DAYS PRIOR TO INSTALL FOR PROGRAMMING.
3	TERMINAL CABINET ON SIGNAL POLE.
4	STRAIN POLE & FOUNDATION, LUMINAIRE & BRACKET ARM. REF TO POLE SCHEDULE
5	TYPE 233 LA SCL DISTRIBUTION HANDHOLE PER SCL CUSTOMER SERVICE DRAWING
6	STREETLIGHT DISTRIBUTION HANDHOLE PER SCL CUSTOMER SERVICE DRAWING.
7	NEW PEDESTAL POLE AND FOUNDATION. MIN CLEARANCE FROM POLE TO EDGE OF SIDEWALK MUST BE 5 FT
8	NEW FISHEYE CAMERA ON NEW LUMINAIRE BRACKET ARM
9	MAINTAIN EX VIDEO DETECTION CAMERA

SIGNAL PLAN – S LUCIL	E	STREET		
	JOB	PC TRC1223 CO TRC1223		
GEORGETOWN TO	VPI # XXXX			
DOWNTOWN PBL	SG06			
	SHE	EET 31 OF 79		

					١	WIRING	SCHEDULE						
RUN NO	SPAN OR CONDUIT SIZE	EXISTING CONDUCTORS	LOOP	LOOP LEAD-IN	PPB 1-PR(SH)	PED HEADS	VEHICLE/BIKE HEAD	CAMERA	SMFO 12CT*	STREET/PED LIGHITNG	SERVICE	GROUND	COMMENTS
1	2-2" SDOT			8-PR								#6	
2	2-2" SDOT			7-PR								#6	
3	2-2" SDOT			3-PR								#6	
4	2-2" SDOT			1-PR								#6	
5	2-2" SDOT			8-PR								#6	
6	1-2" SDOT						1-5C					#6	
7	2-3" SDOT			8-PR	1		3-5C	1-CCC				#6	
8	SPAN			13-PR	5		2-10C, 2-5C	1-CCC				#6	
9	1-2" SDOT				1	1-3C						#6	
10	EX RISER			7-PR	3	4-3C	2-5C					#6	
11	SPAN			7-PR	4	4-3C	1-10C, 2-5C					#6	
12	SPAN						1-10C					#6	
13	EX 2-3"				2	2-3C	1-10C	1-CCC				#6	
14	EX 3-3"			22-PR	8	8-3C	2-10C	2-CCC				#6	
15	2-3" SL										2-#2	**	
16	2" RISER									2-#6(L,N)		#6	
17	SPAN									2-#6(L,N)		#6	
18	SPAN									3-#12 (L, N)		#6	CONNECT TO LUMINAIRE
19	2-2" SL											#6	SPARE

**GROUND PER SCL STANDARDS

-GEORGETOWN 2023 2:33PM

TRC1223-JUNE 01

NOTE: ALL CONDUIT WITH CONDUCTORS MUST CONTAIN A #6 GROUNDWIRE

	APPROVED FOR ADVERTISING DEPARTMENT OF FINANCE & ADMINISTRATIVE SERVICES SEATTLE, WASHINGTON	INITIALS AND DATE DESIGNED CHECKED	INITIALS AND DATE REVIEWED: DES. CONST. SDOT PROJ. MGR.		Seattle Department of Transportation
PW#XXXX-XX		DRAWN	RECEIVED	49491	
	BY:	CHECKED ALL WORK SHALL BE DONE IN ACCORDANCE WITH SPECIFICATIONS AND OTHER DOCUMENTS CALLED FO	REVISED AS BUILT THE CITY OF SEATTLE STANDARD PLANS AND DR IN SECTION 0-02.3 OF THE PROJECT MANUAL.	ASCISTERED OF	SCALE: AS NOTED

SEE STD PLAN 522b FOR PEDESTRIAN PUSHBUTTON ASSEMBLY O' AZIMUTH = NORTHBOUND

PPB/BPP

NO.

PPB28

PPB29

PPB46


PPB47

PPB29

PPB28

PPB66


PPB67

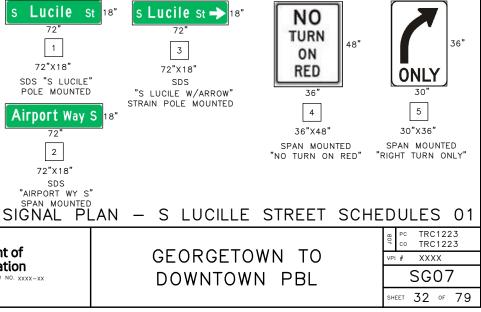

1- CONTRACTOR TO PROCURE APS CONTROLLER INTERFACES TO SDOT SIGNALS SHOP FOR INSTALL INTO NEW TRAFFIC SIGNAL CONTROLLER CABINET SIGNS

PEDESTRIAN SIGNALS LOCATION (0° POLE AZIMUTH PHASE ARROW DIRECTION NO. CLOCKWISE)* LOOKING AT RAPID TICK SIGN PUSHBUTTON P01 R10-3 270 2 LEFT RAPID TICK P07 270 2 R10-3 RIGHT RAPID TICK 0 RAPID TICK P05 4 R10-3 RIGHT P06 0 4 R10-3 LEFT RAPID TICK P06 270 2 R10-3 RIGHT RAPID TICK P08 90 2 R10-3 RIGHT RAPID TICK P03 90 6 R10-3 RIGHT RAPID TICK 90 R10-3 LEFT RAPID TICK P04 6

(PPB) APS PUSHBUTTON MOUNTING SCHEDULE

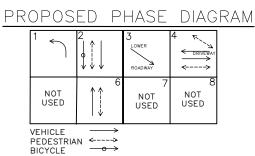

**PHASE 2 IS SB AIRPORT WY S

VEHICLE PEDESTRIAN <----> **PHASE 2 IS SB AIRPORT WY S

-----> V V <----> NOT USED NOT

EXISTING PHASE DIAGRAM

LOOP SCHEDULE								
LOOP NO.	PHASE	NO. OF TURNS	ЪРЕ	INDUCTANCE	NOTES			
L11	1	4						
L12	1	4						
L13	1	4						
L11B	1	4	PARALLELOGRAM					
L21	2	4						
L22	2	4						
L23	2	4						
L24	2	4						
L25	2	4						
L26	2	4						
L21B	2	-	PARALLELOGRAM					
L22B	2	-	PARALLELOGRAM					
L31	3	4						
L32	3	4						
L41	4	4						
L42	4	4						
L43	4	4						
L63	6	4						
L63	6	4						
L63	6	4						


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-GEORGETOWN 2023 2:33PM

TRC1223-JUNE 01

POLE/PEDESTAL SCHEDULE

POLE NO. "PSG05-"	STATION/LOCATION AND OFFSET	POLE TYPE	LENGTH (FT)	FOUNDATION TYPE	LUMINAIRE ARM LENGTH (FT)	LUMINAIRE WATTAGE	LUMINAIRE MOUNTING HEIGHT (FT)
01	41+37.9, 5.1'LT	STEEL STRAIN POLE	33.5	PER DETAIL	10.0	195/LED	35.0
02	41+31.3, 12'LT	RELOCATED PEDESTAL	EX	STD PLAN NO. 524	-	-	-
03	EX	EX PEDESTAL	10	-	-	-	-
04	41+ 46.2, 120.7' LT	ALUMINUM PEDESTAL	10	STD PLAN NO. 524	-	-	-
05	41+79'146'LT	RELOCATED PEDESTAL	10	STD PLAN 524	-	-	-
06	42+19.2, 93.5' LT	PEDESTAL	10	STD PLAN 524	-	-	-
07	42+11.4, 65'LT	RELOCATED PEDESTAL	EX	STD PLAN 524	-	-	-



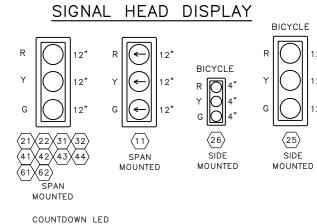


2829 RIGHT MOUNTED

60% SUBMITTAL NOT FOR CONSTRUCTION JUNE 2023

Seattle Department of Transportation APPROVED FOR ADVERTISING INITIALS AND DATE INITIALS AND DATE VIEWED DESIGNED DEPARTMENT OF FINANCE & ADMINISTRATIVE SERVICES CONST HECKED S. PROJ. MGR PW#XXXX-XX RECEIVED DRAWN RDINANCE NO. PW NO. XXXX-XX IECKED REVISED AS BUILT BY:PURCHASING AND CONTRACTING ALL WORK SHALL BE DONE IN ACCORDANCE WITH THE CITY OF SEATTLE STANDARD PLANS A SPECIFICATIONS AND OTHER DOCUMENTS CALLED FOR IN SECTION 0-02.3 OF THE PROJECT SCALE: AS NOTED

SIGNAL

ΡL	AN – S LUCILLE STREET SCHE	D	ULES	02	
	GEORGETOWN TO	80 VP	PC TRC122 CO TRC122		
	DOWNTOWN PBL	SG08			
		SH	IEET 33 OF	79	

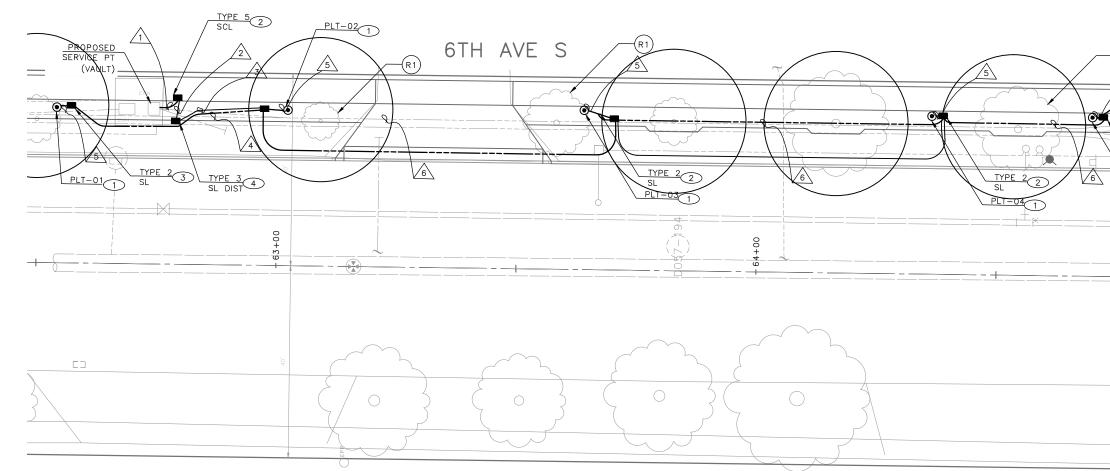

INSTALL:


- 1 INSTALL PEDESTRIAN LUMINAIRE, PEDESTRIAN LUMINAIRE POLE AND FOUNDATION. REFER TO POLE SCHEDULE.
- 2 INSTALL SCL DISTRIBUTION HANDHOLE PER SCL CUSTOMER SERVICE DRAWING.
- (3) INSTALL TYPE 2 SL HANDHOLE PER SCL CONSTRUCTION STANDARDS.
- (4) INSTALL TYPE 3 SL DISTRIBUTION HANDHOLE PER SCL CONSTRUCTION STANDARDS.


REMOVE/RELOCATE:

(R1) REMOVE EX TREE. REF TO SITE PREP DRAWINGS FOR MORE INFORMATION.

60% SUBMITTAL NOT FOR CONSTRUCTION JUNE 2023

PW#XXXX-XX	SEATTLE, WASHINGTON	INITIALS AND DATE DESIGNED CHECKED	INITIALS AND DATE REVIEWED: DES. CONST. SDOT PROJ. MGR.		Seattle Department of
		DRAWN CHECKED ALL WORK SHALL BE DONE IN ACCORDANCE WITH	RECEIVED REVISED AS BUILT THE CITY OF SEATTLE STANDARD PLANS AND	49491 A9491 Maisternal City	
	PURCHASING AND CONTRACTING	SPECIFICATIONS AND OTHER DOCUMENTS CALLED F	OR IN SECTION 0-02.3 OF THE PROJECT MANUAL.	The second se	SCALE: AS NUTED

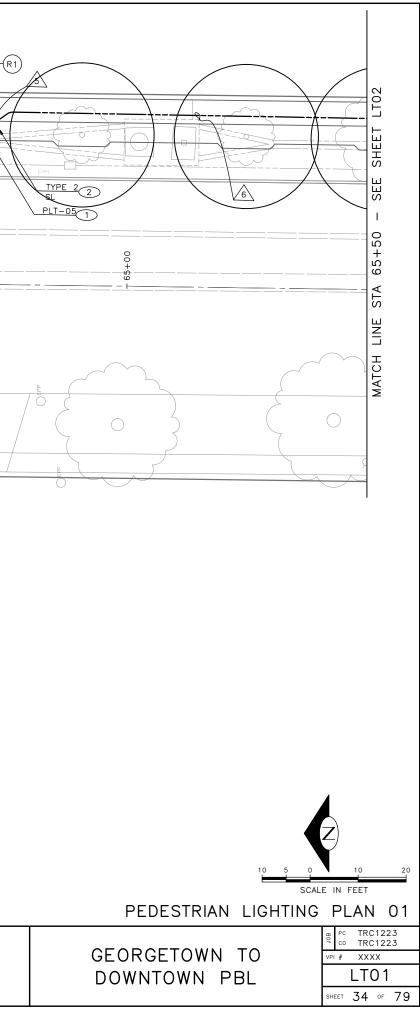

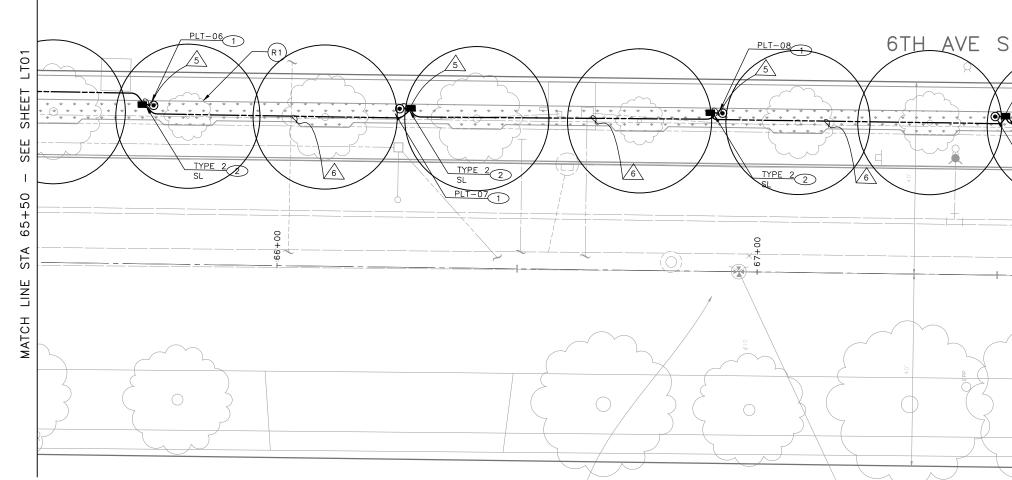

INSTALL:

- 1 INSTALL PEDESTRIAN LUMINAIRE, PEDESTRIAN LUMINAIRE POLE AND FOUNDATION. REFER TO POLE SCHEDULE.
- 2 INSTALL SCL DISTRIBUTION HANDHOLE PER SCL CUSTOMER SERVICE DRAWING.
- (3) INSTALL TYPE 2 SL HANDHOLE PER SCL CONSTRUCTION STANDARDS.
- (4) INSTALL TYPE 3 SL DISTRIBUTION HANDHOLE PER SCL CONSTRUCTION STANDARDS.


REMOVE/RELOCATE:

R1 REMOVE EX TREE. REF TO SITE PREP DRAWINGS FOR MORE INFORMATION.


TRC1223-GEORGETOWN TO DOWNTOWN PBL\PROJECT FILES\CIVIL\02-SHEETS\TRC1223_P-LITE.DWG JUNE 01 2023 10:05AM

60% SUBMITTAL NOT FOR CONSTRUCTION JUNE 2023

PW#XXXX-XX	APPROVED FOR ADVERTISING DEPARTMENT OF FINANCE & ADMINISTRATIVE SERVICES SEATTLE, WASHINGTON	DESIGNED CHECKED DRAWN	RECEIVED	00 140 66 9 140 19491	Transportation
	BY:Purchasing and contracting	ALL WORK SHALL BE DONE IN ACCORDANCE WITH SPECIFICATIONS AND OTHER DOCUMENTS CALLED FO	THE CITY OF SEATTLE STANDARD PLANS AND OR IN SECTION 0-02.3 OF THE PROJECT MANUAL.	ANCISTERE PUCIFIC	SCALE: AS NOTED

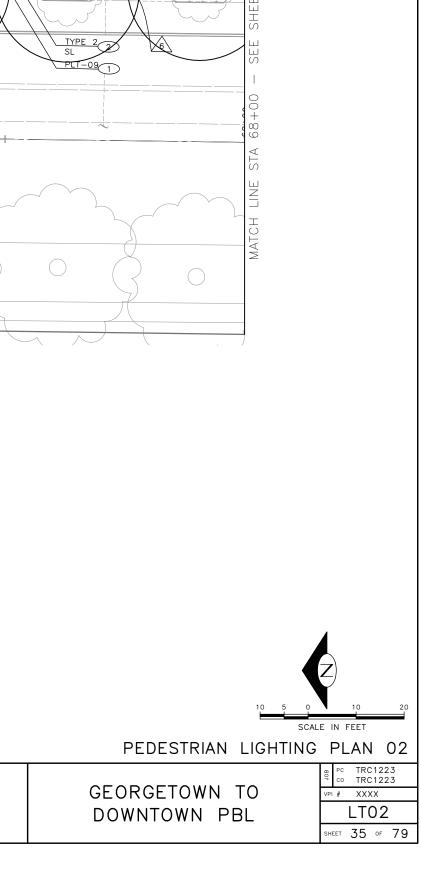

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INSTALL:

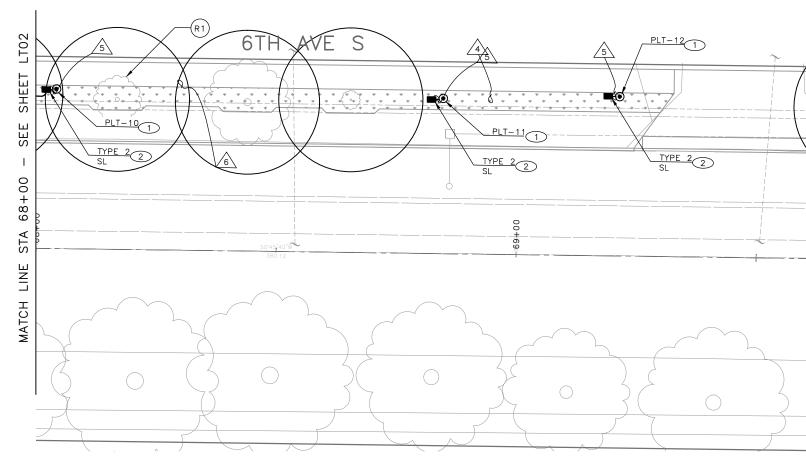- 1 INSTALL PEDESTRIAN LUMINAIRE, PEDESTRIAN LUMINAIRE POLE AND FOUNDATION. REFER TO POLE SCHEDULE.
- 2 INSTALL SCL DISTRIBUTION HANDHOLE PER SCL CUSTOMER SERVICE DRAWING.
- 3 INSTALL TYPE 2 SL HANDHOLE PER SCL CONSTRUCTION STANDARDS.
- (4) INSTALL TYPE 3 SL DISTRIBUTION HANDHOLE PER SCL CONSTRUCTION STANDARDS.


REMOVE/RELOCATE:


R1 REMOVE EX TREE. REF TO SITE PREP DRAWINGS FOR MORE INFORMATION.

TRC1223-GEORGETOWN TO DOWNTOWN PBL\PROJECT FILES\CIVIL\02-SHEFTS\ JUNE 01 2023 10:06AM

60% SUBMITTAL NOT FOR CONSTRUCTION JUNE 2023

	APPROVED FOR ADVERTISING DEPARTMENT OF FINANCE & ADMINISTRATIVE SERVICES	INITIALS AND DATE DESIGNED CHECKED	INITIALS AND DATE REVIEWED: DES. CONST. SDOT PROJ. MGR.		Seattle Department of
PW#XXXX-XX		DRAWN CHECKED ALL WORK SHALL BE DONE IN ACCORDANCE WITH	RECEIVED REVISED AS BUILT	49491 ABUISTERE DIG	ORDINANCE NO. PW NO. XXXX-XX

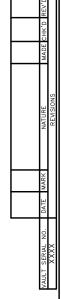

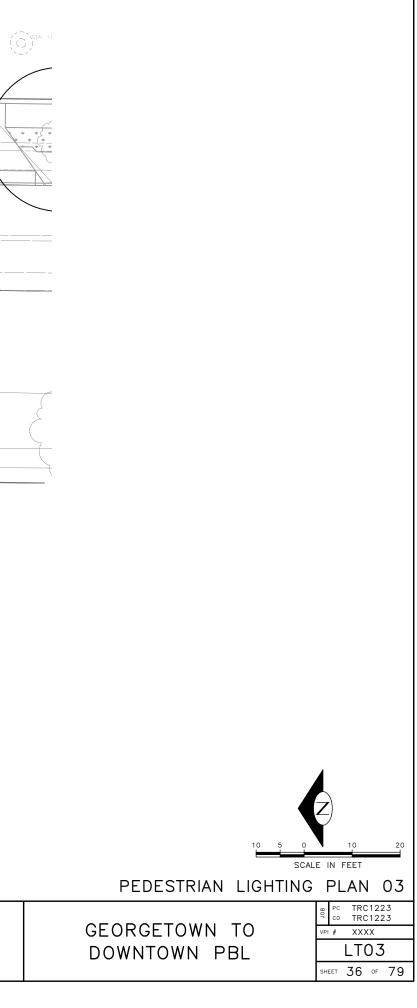

WIRING SCHEDULE

RUN NO	CONDUIT SIZE	STREET/PED LIGHITNG	SERVICE	GROUND	COMMENTS
1	1-3" RISER	-	3-#2	**	NEW SERVICE
2	1-3"SL	-	3-#2	**	
3	2-2"SL	3-#2 (L1,L2,N)	-	#6	
4	2-2"SL	2-#6(L,N)	-	#6	
5	1-2" SL	3-#12 (L, N)	-	#6	FEED INTO POLE
6	2-2" SL	3-#6(L1,L2,N)	-	#6	

** INDICATES THAT GROUNDING MUST BE PER SCL STANDARD 0231.01
1. ALL GROUNDWIRE MUST BE #6 AWG, UNLESS OTHERWISE NOTED. ALL CONDUIT WITH A CONDUCTOR MUST CONTAIN A GROUNDWIRE
2. ALL MATERIALS MUST MEET SCL MATERIAL STANDARDS
3. ALL STREETLIGHTING MUST BE GROUND PER SCL STANDARD 1714.50
4. #4 CU AWG GROUNDWIRE MUST BE INSTALLED IN ALL TRENCHES AND TIED TO GROUND RODS. REF TO SCL STD 1714.50 AND 0461.10

		,						
POLE NO.	STATION/LOCATION AND OFFSET	POLE TYPE	LENGTH (FT)	FOUNDATION TYPE	MAST ARM LENGTH (FT)	LUMINAIRE ARM LENGTH (FT)	LUMINAIRE WATTAGE	LUMINAIRE MOUNTING HEIGHT (FT)
P01-1	XX+XX.XX, XX.XX	PEDESTRIAN, AL LIGHTING	14	STD PLAN 543B	-	-	70	14
P01-2	XX+XX.XX, XX.XX	PEDESTRIAN, AL LIGHTING	14	STD PLAN 543B	-	-	70	14
P01-3	XX+XX.XX, XX.XX	PEDESTRIAN, AL LIGHTING	14	STD PLAN 543B	Ι	_	70	14
P01-4	XX+XX.XX, XX.XX	PEDESTRIAN, AL LIGHTING	14	STD PLAN 543B	-	-	70	14
P01-5	XX+XX.XX, XX.XX	PEDESTRIAN, AL LIGHTING	14	STD PLAN 543B	-	-	70	14
P01-6	XX+XX.XX, XX.XX	PEDESTRIAN, AL LIGHTING	14	STD PLAN 543B	-	-	70	14
P01-7	XX+XX.XX, XX.XX	PEDESTRIAN, AL LIGHTING	14	STD PLAN 543B	-	-	70	14
P01-8	XX+XX.XX, XX.XX	PEDESTRIAN, AL LIGHTING	14	STD PLAN 543B	-	-	70	14
P01-9	XX+XX.XX, XX.XX	PEDESTRIAN, AL LIGHTING	14	STD PLAN 543B	-	-	70	14
P01-10	XX+XX.XX, XX.XX	PEDESTRIAN, AL LIGHTING	14	STD PLAN 543B	-	-	70	14
P01-11	XX+XX.XX, XX.XX	PEDESTRIAN, AL LIGHTING	14	STD PLAN 543B	-	-	70	14
P01-12	XX+XX.XX, XX.XX	PEDESTRIAN, AL LIGHTING	14	STD PLAN 543B	-	-	70	14
. POLE TYPE	DEFINED HERE							

POLE TYPE DEFINED HERE
 LUMINAIRE TYPE/STYLE DEFINED HERE
 POLE BASE COVER DEFINED HERE

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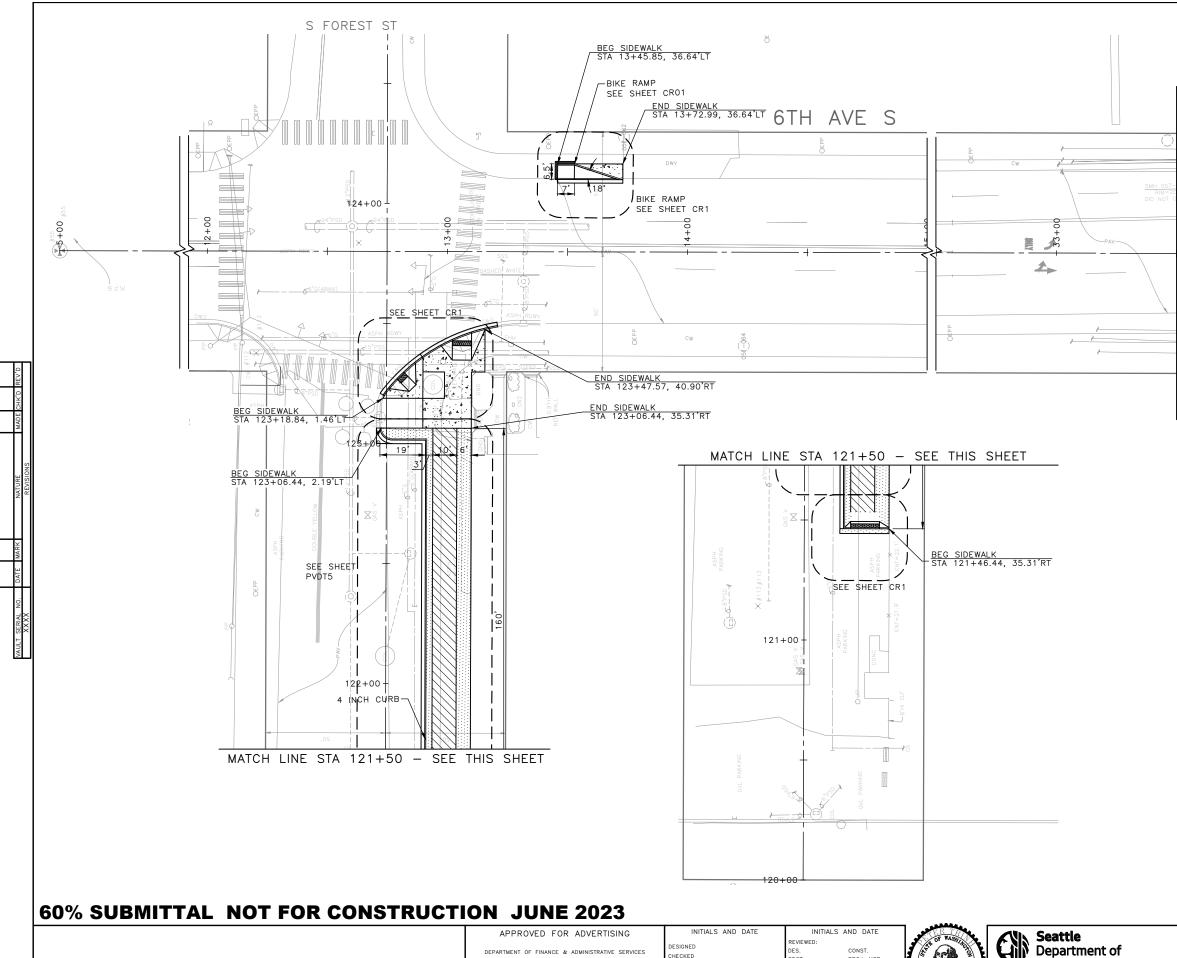
TRC1223-GEORGETOWN TO JUNE 01 2023 10:06AM

	APPROVED FOR ADVERTISING	INITIALS AND DATE	INITIALS AND DATE	NN MAR	KUIN Seattle
	DEPARTMENT OF FINANCE & ADMINISTRATIVE SERVICES	DESIGNED CHECKED	REVIEWED: DES. CONST. SDOT PROJ. MGR.		Department of
PW#XXXX-XX		DRAWN	RECEIVED	49491	
		CHECKED	REVISED AS BUILT	A ABCICOTERS	
	BY:	ALL WORK SHALL BE DONE IN ACCORDANCE WITH SPECIFICATIONS AND OTHER DOCUMENTS CALLED F		SIONAL EN	SCALE: AS NOTED

POLE/PEDESTAL SCHEDULE

GEORGETOWN TO	
DOWNTOWN PBL	

JOB	PC	TRC	122	23				
ρŗ	со	TRC	2122	23				
VPI	#	XXX	<x< th=""><th></th><th></th></x<>					
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	APPROVED FOR ADVERTISING DEPARTMENT OF FINANCE & ADMINISTRATIVE SERVICES SEATTLE, WASHINGTON	DESIGNED	INITIALS AND DATE REVIEWED: DES. CONST. SDOT PROJ. MGR.	ALL OF MARINE	Seattle Department of Transportation
PW#XXXX-XX	,	DIGHT	RECEIVED REVISED AS BUILT	51781 PRECISTERED	ORDINANCE NO. PW NO. XXXX-XX
		ALL WORK SHALL BE DONE IN ACCORDANCE WITH SPECIFICATIONS AND OTHER DOCUMENTS CALLED FO	THE CITY OF SEATTLE STANDARD PLANS AND IN IN SECTION 0-02.3 OF THE PROJECT MANUAL.	STONAL EN	SCALE: H. 1"=20', V. 1"=10'

D

CONSTRUCTION NOTES

1 DETECTABLE STRIP SEE DETAIL 1 ON SHEET PVDT01

- 2 RELOCATE HYDRANT
- 3 CEMENT CONCRETE SEE DETAIL 2 ON SHEET PVDT01
- (4) REMOVE EXISTING GRATE AND REPLACE WITH VANED GRATE PER STD PLAN 265
- 5 Remove existing grate and replaced with vaned grate per STD plan 266

PAVING LEGEND

PER STD PLANS 420 & 421


- 8" CEM CONC DRIVEWAY (24 HR HES), PER STD PLAN 430 SIDEWALK CEM CONC W/25% POZZOLANS,
- `b4
 - 2" HMA CL1/2" OVER 4" MNRL AGG TYPE 2
- 3" HMA CL1/2" OVER 4" MNRL AGG TYPE 2
- 6" HMA CL1/2" OVER 4" MNRL AGG TYPE 2
- - ☐ 3" CONC TRUCK APRON
- LANDSCAPE RESTORATION TO BE DETERMINED


CURB RAMP W/25% POZZOLANS,


PER CR PLANS (REM SIDEWALK)

- EEM CONC CURB & GUTTER W/25% POZZOLANS, PER STD PLAN 410B
- • PRE-CAST CURB

MATCH LINE STA 33+50 - SEE SHEET PV02

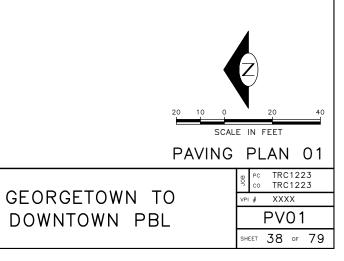


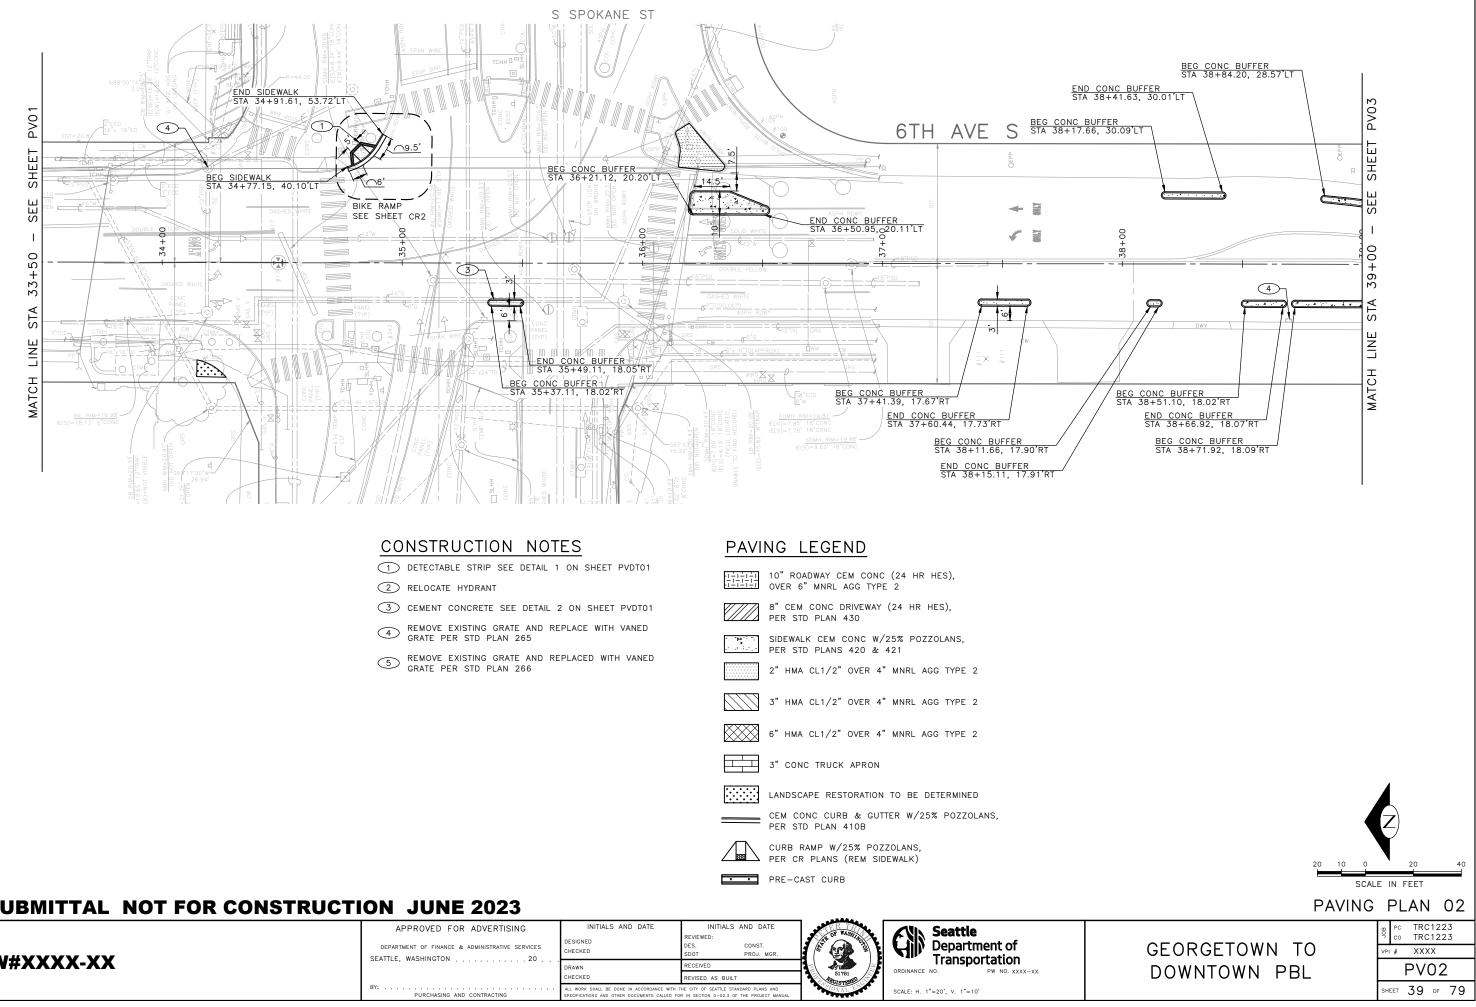

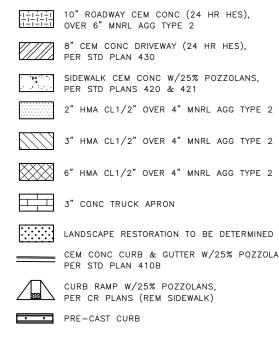


60% SUBMITTAL NOT FOR CONSTRUCTION JUNE 2023

	APPROVED FOR ADVERTISING	INITIALS AND DATE	INITIALS AND DATE	SER TRA	VIN Seattle
PW#XXXX-XX	DEPARTMENT OF FINANCE & ADMINISTRATIVE SERVICES	DESIGNED CHECKED	REVIEWED: DES. CONST. SDOT PROJ. MGR.		Department of
	SEATTLE, WASHINGTON	DRAWN CHECKED	RECEIVED REVISED AS BUILT	51781	ORDINANCE NO. PW NO. XXXX->
	BY:	ALL WORK SHALL BE DONE IN ACCORDANCE WITH T SPECIFICATIONS AND OTHER DOCUMENTS CALLED FO	THE CITY OF SEATTLE STANDARD PLANS AND	NAL WALL	SCALE: H. 1"=20', V. 1"=10'

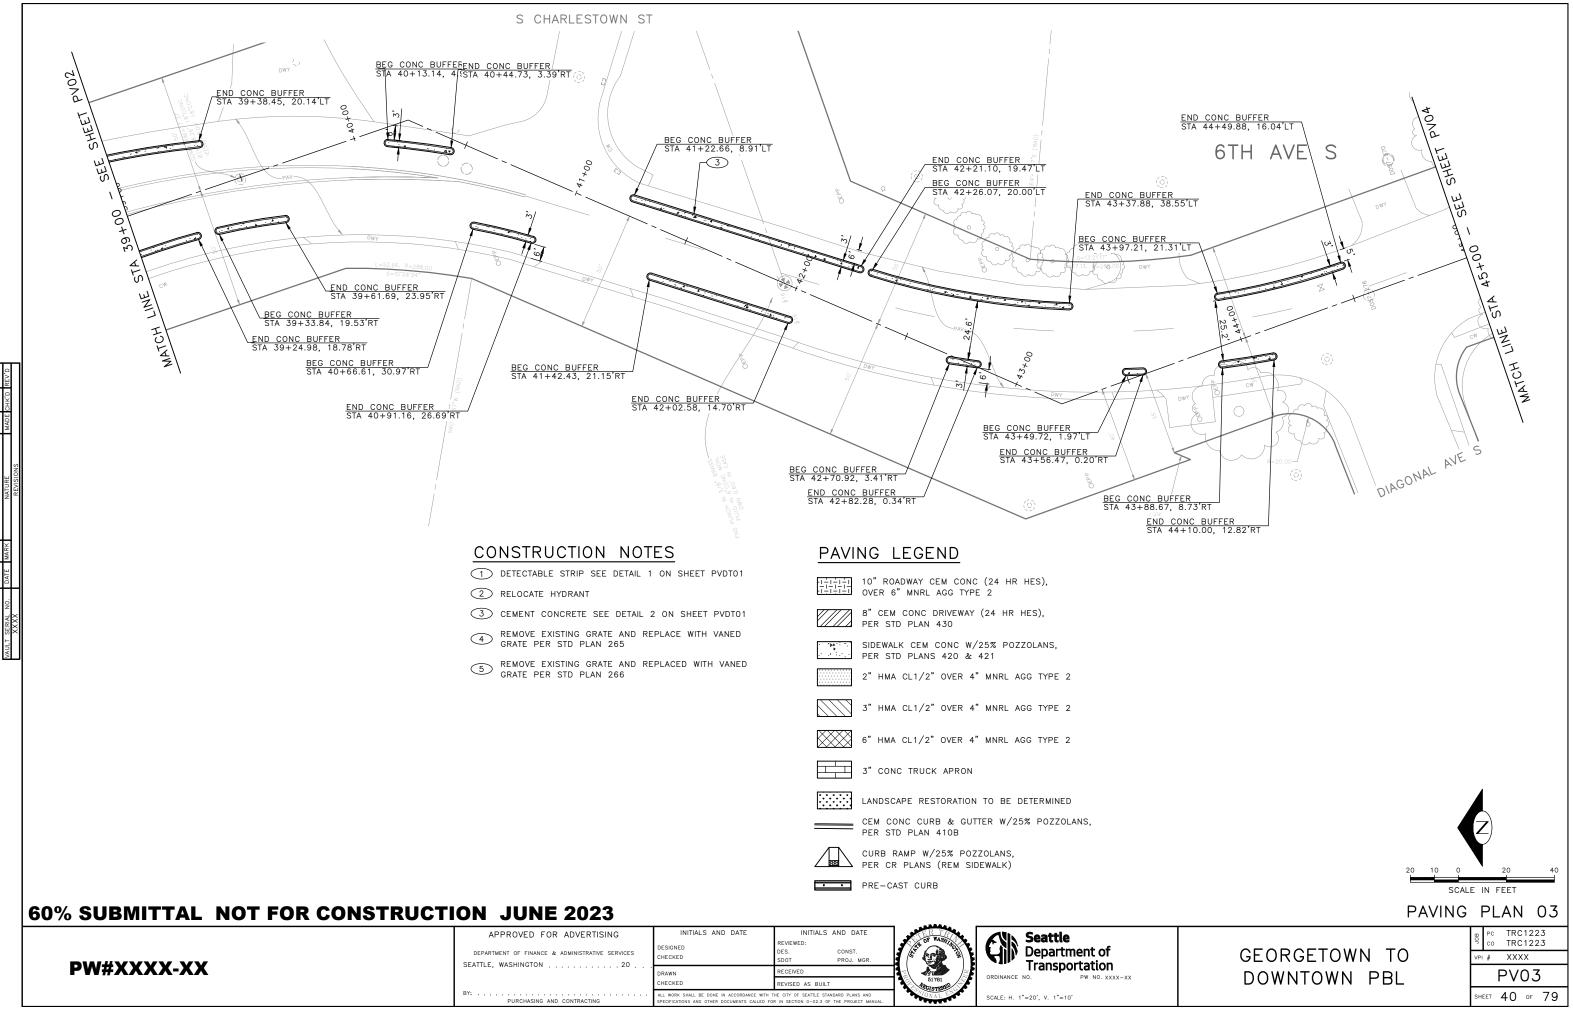


PW#XXXX-XX	DEPARTMENT OF FINANCE & ADMINISTRATIVE SERVICES SEATTLE, WASHINGTON	INITIALS AND DATE DESIGNED CHECKED	INITIALS AND DATE REVIEWED: DES. CONST. SDOT PROJ. MGR.	A CONTROL OF	ST WASHINGTON	y y y y y y y y y y y y y y y y y y y		Seattle Department of Transportation
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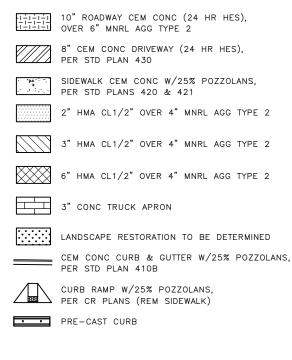
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- 1 DETECTABLE STRIP SEE DETAIL 1 ON SHEET PVDT01
- 2 RELOCATE HYDRANT
- 3 CEMENT CONCRETE SEE DETAIL 2 ON SHEET PVDT01
- REMOVE EXISTING GRATE AND REPLACE WITH VANED GRATE PER STD PLAN 265
- 5 REMOVE EXISTING GRATE AND REPLACED WITH VANED GRATE PER STD PLAN 266

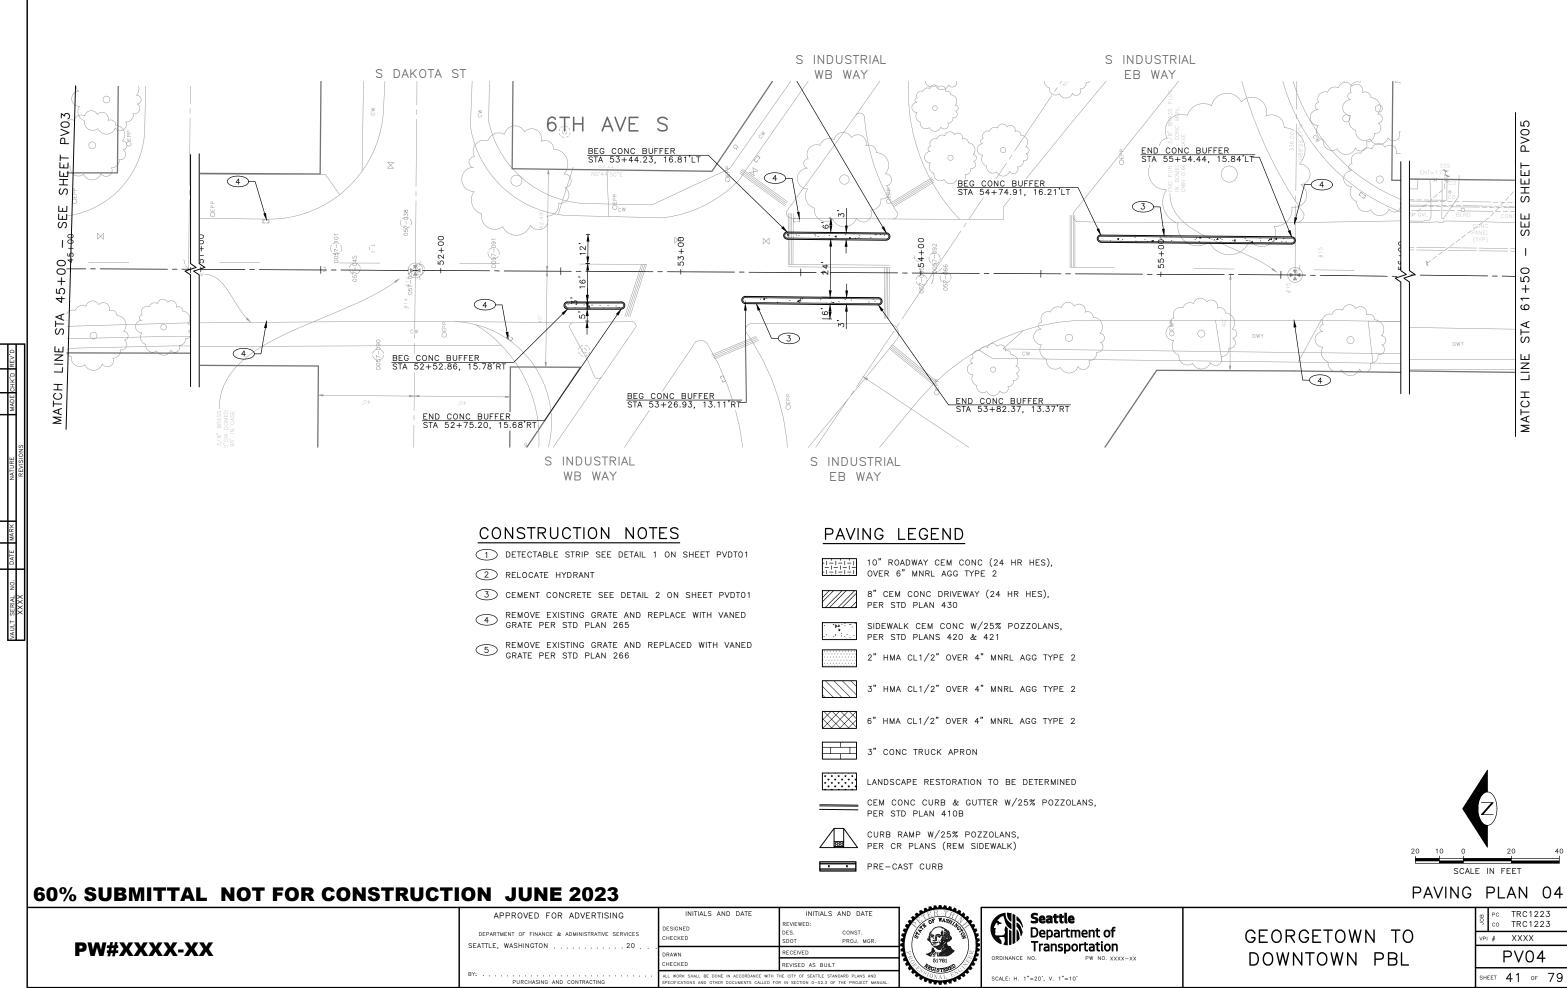PAVING LEGEND




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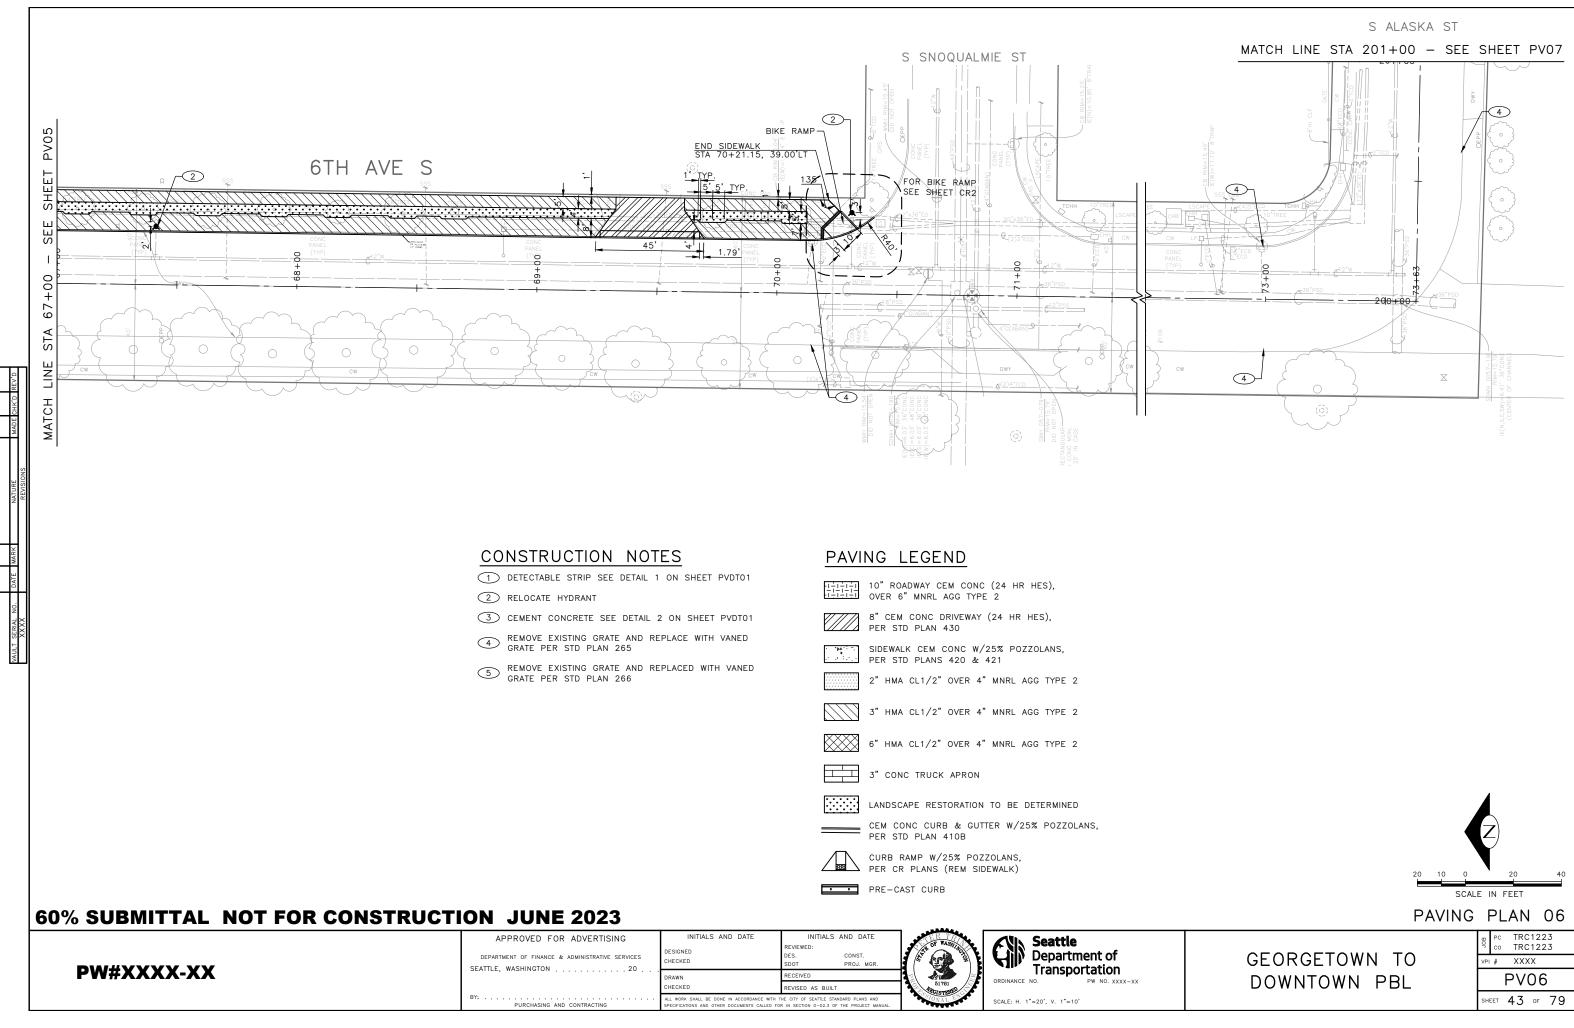
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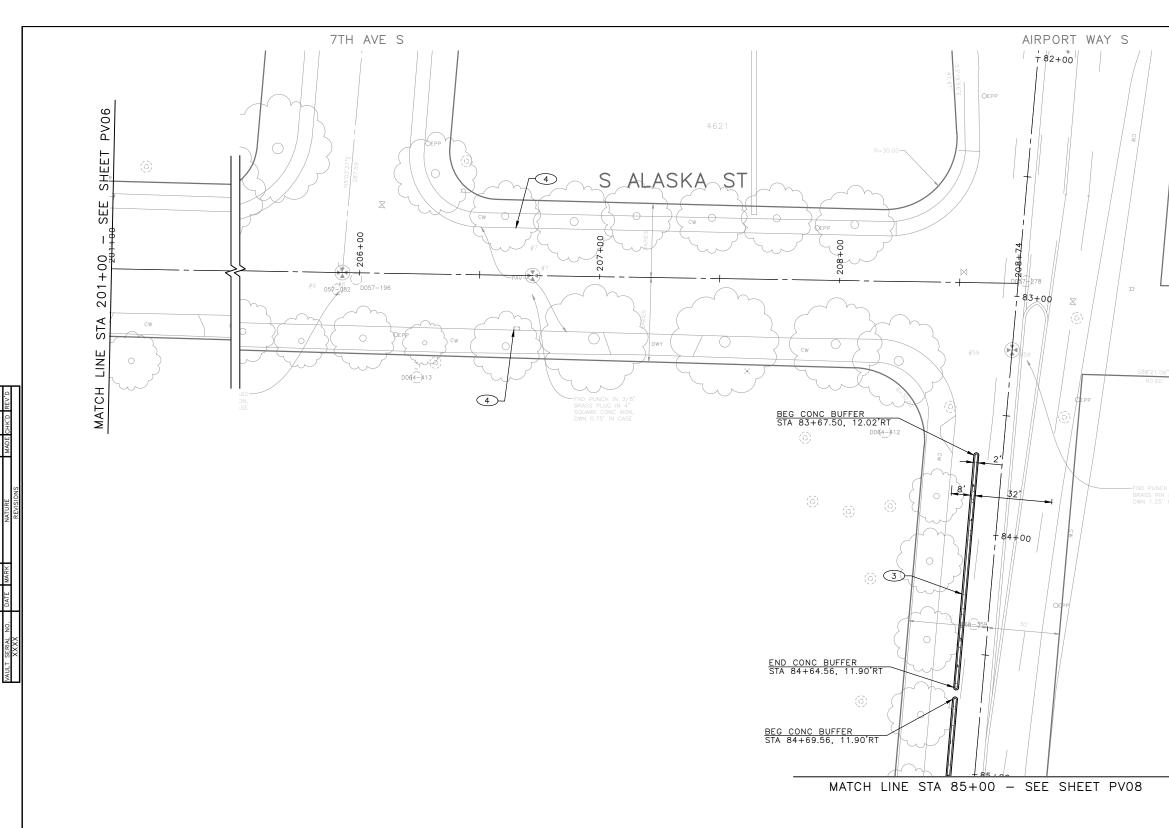
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DEPARTMENT OF FINANCE & ADMINISTRATIVE SERVICES	CHECKED

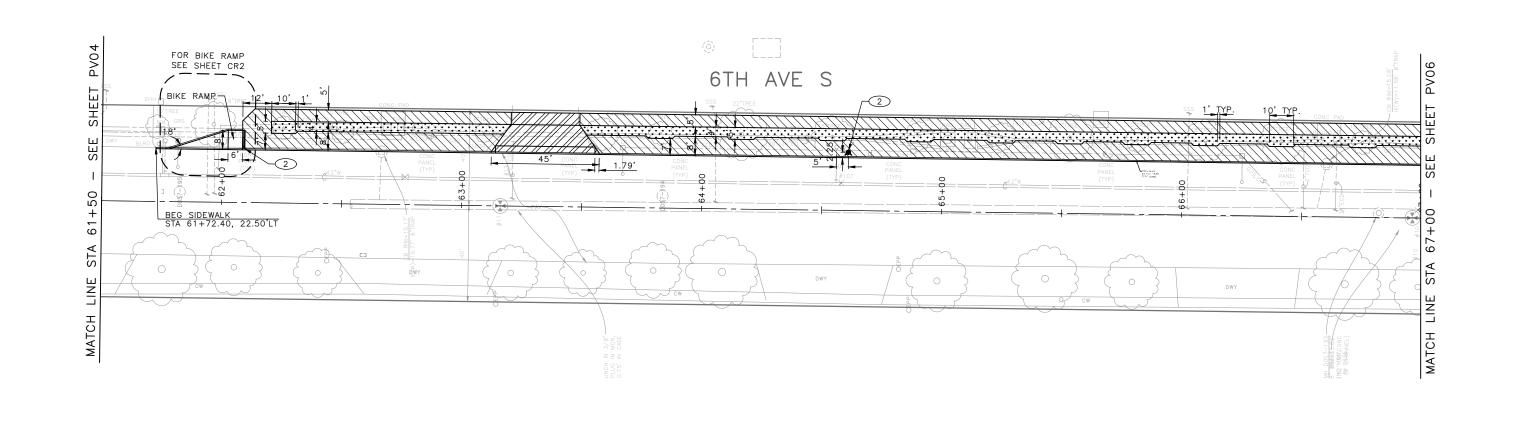


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Ξ	PAVING LEGEND III III IIII IIIIIIIIIIIIIIIIIIIIIIIIIIIIIIIIIIII
IN 1/8" N CONC MON, N CASE	6" HMA CL1/2" OVER 4" MNRL AGG TYPE 2 3" CONC TRUCK APRON LANDSCAPE RESTORATION TO BE DETERMINED CEM CONC CURB & GUTTER W/25% POZZOLANS, PER STD PLAN 410B CURB RAMP W/25% POZZOLANS, PER CR PLANS (REM SIDEWALK) PRE-CAST CURB
_	Z
	20 10 0 20 40 SCALE IN FEET PAVING PLAN 07
	GEORGETOWN TO DOWNTOWN PBL




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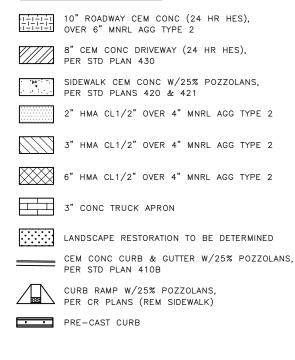
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- 1 DETECTABLE STRIP SEE DETAIL 1 ON SHEET PVDT01
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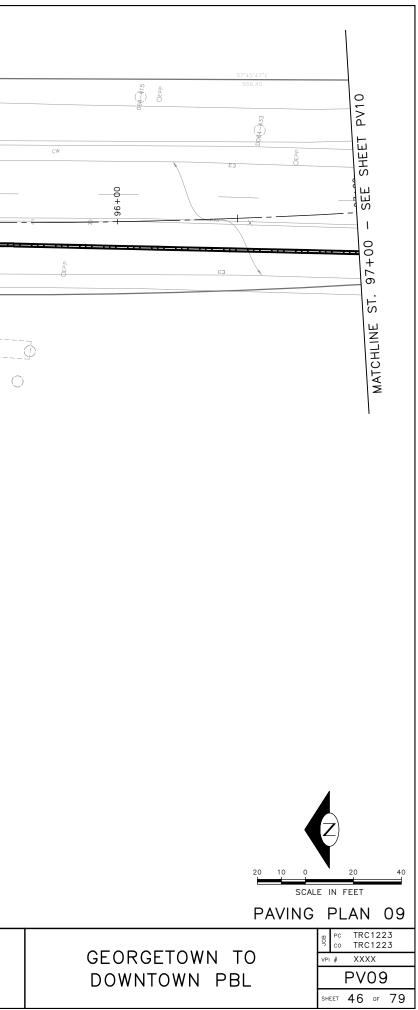
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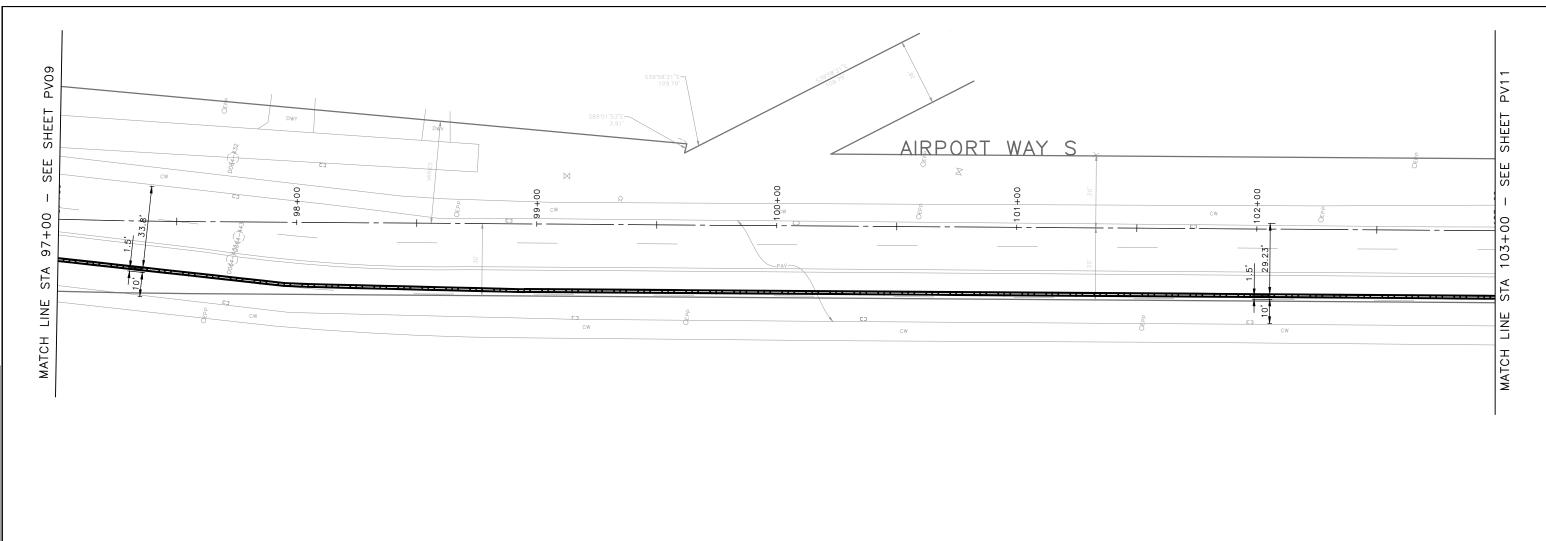
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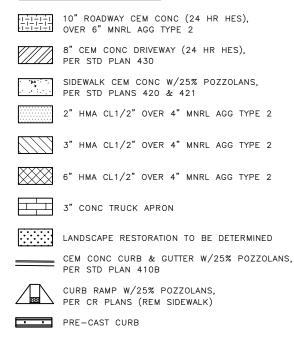
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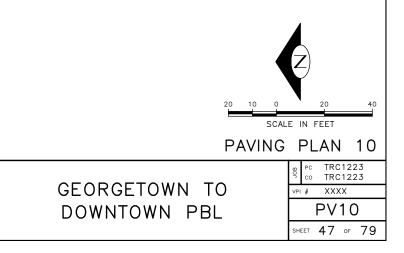
- 1 DETECTABLE STRIP SEE DETAIL 1 ON SHEET PVDT01
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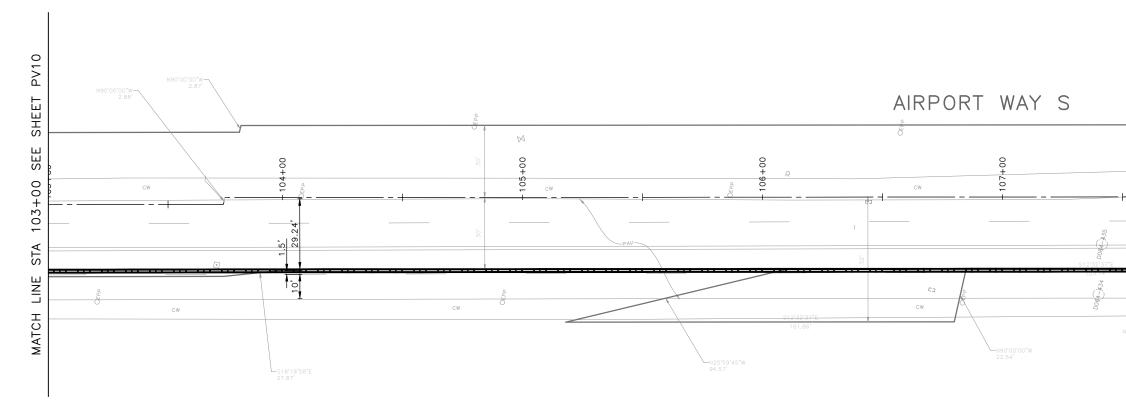
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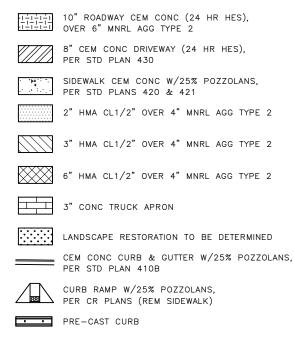
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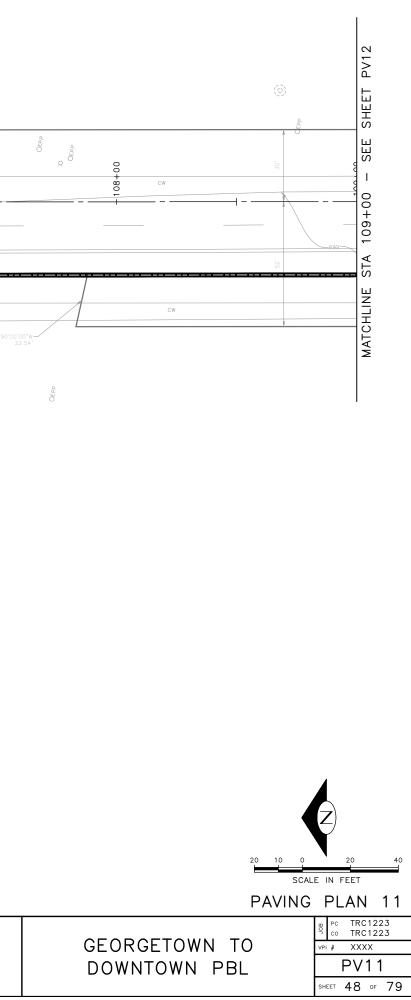
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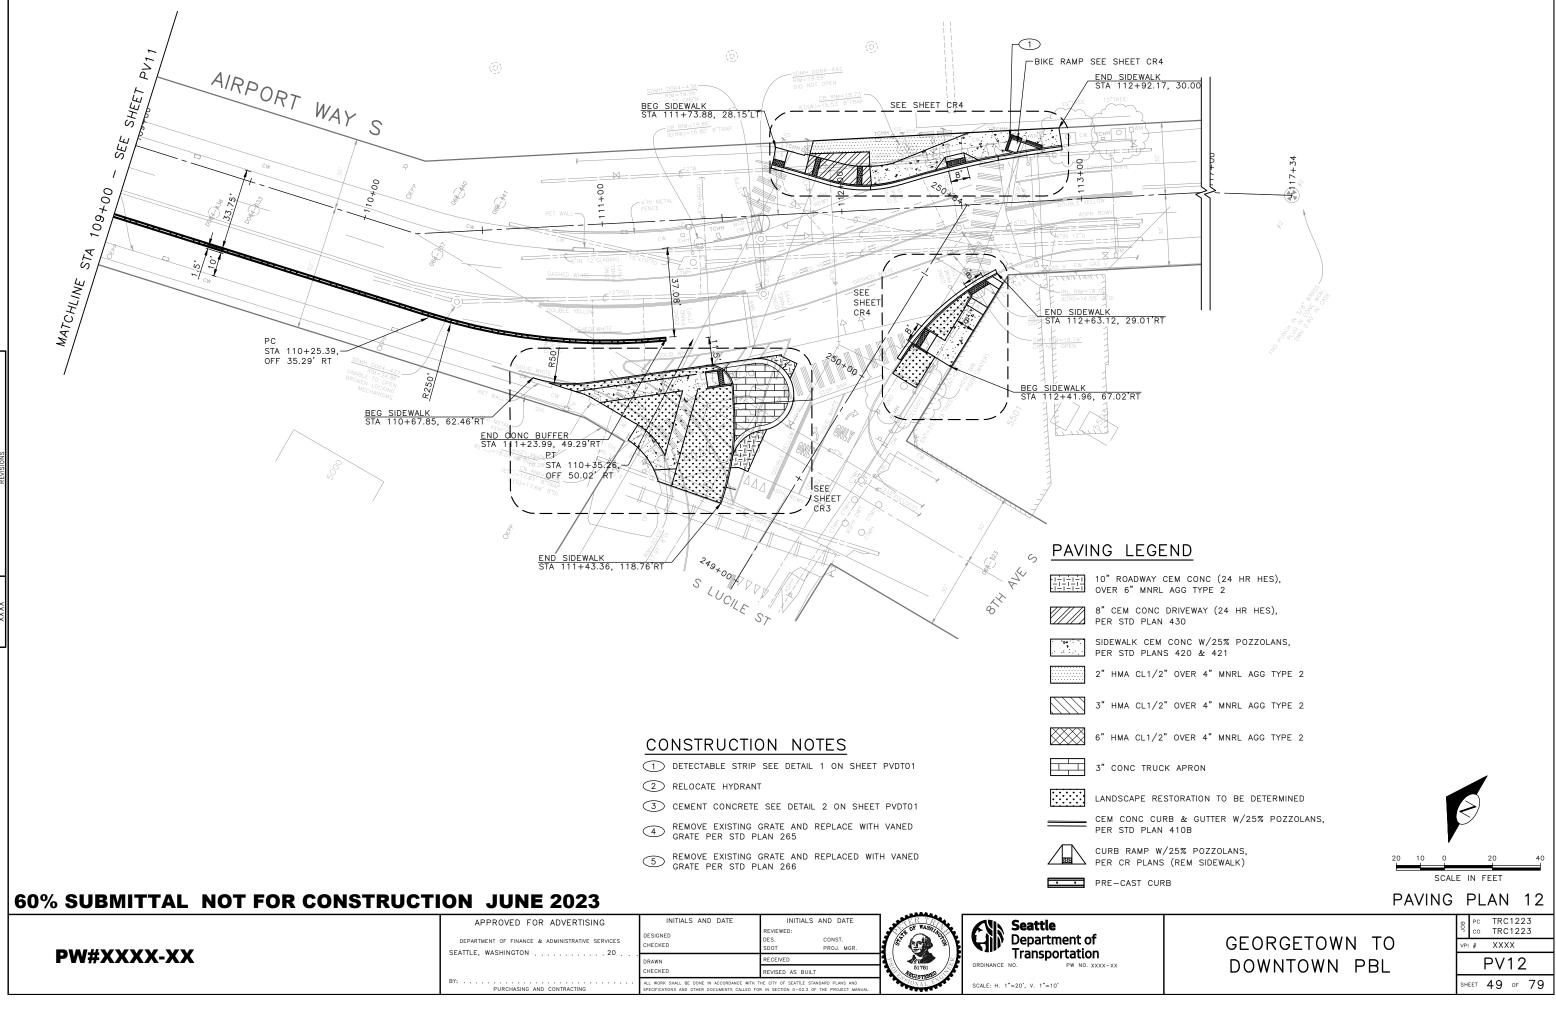
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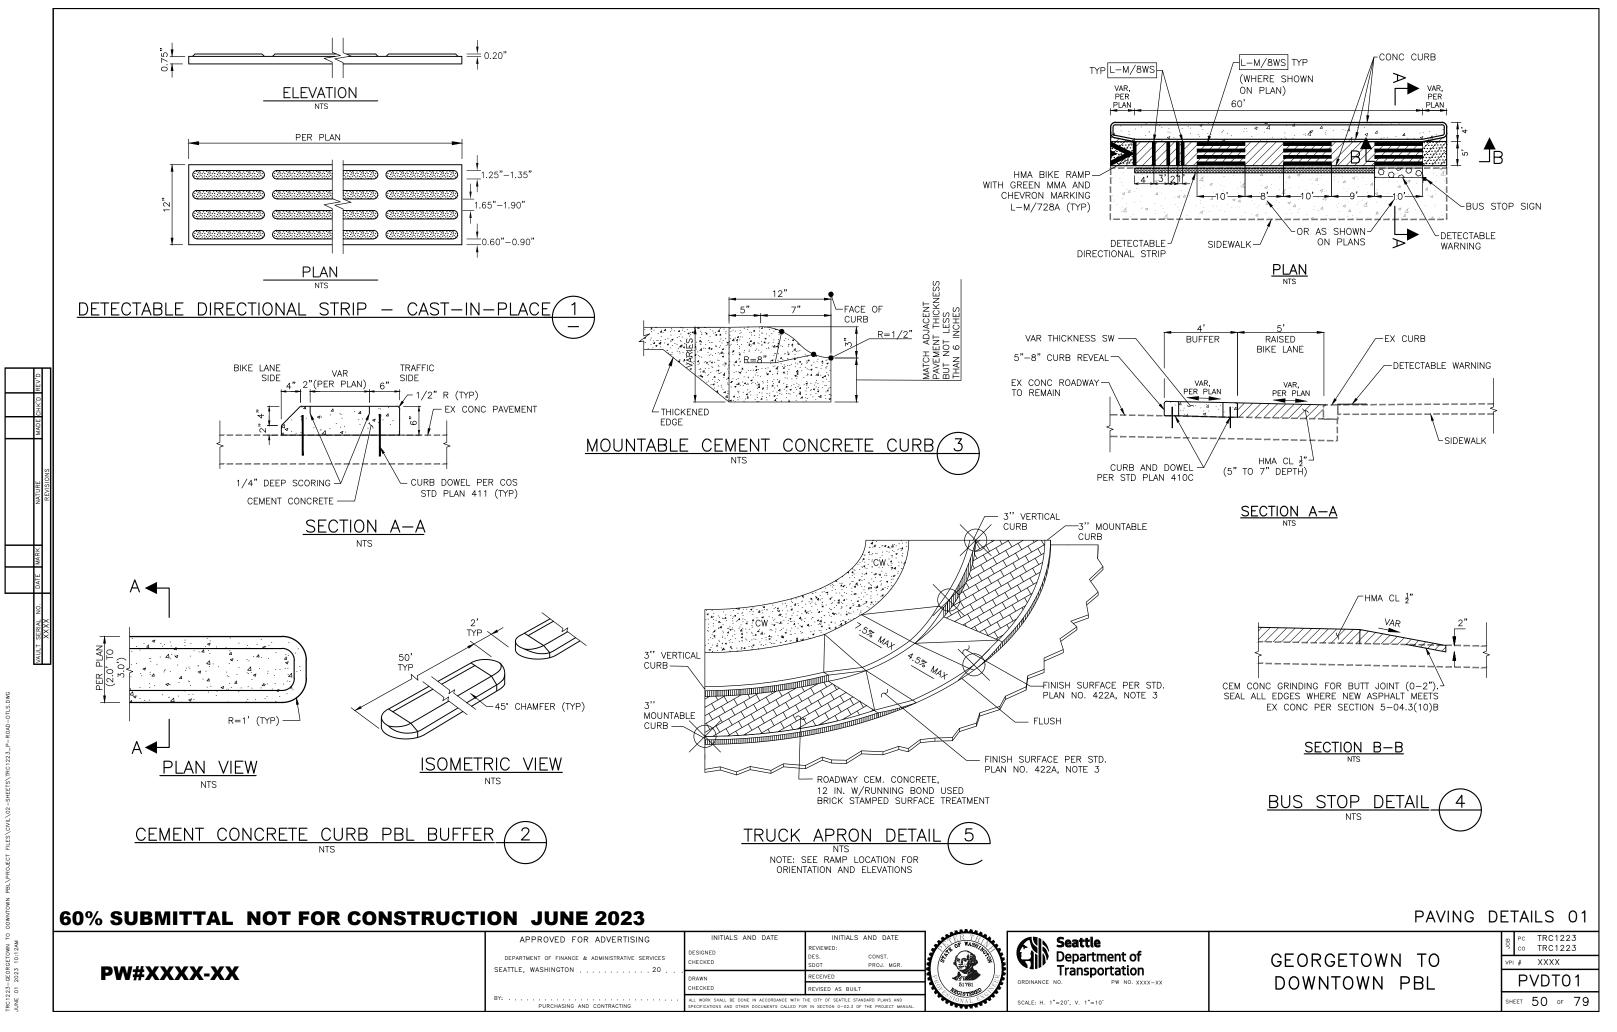
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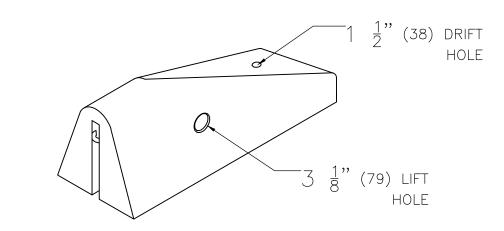

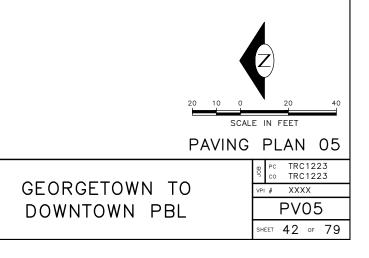
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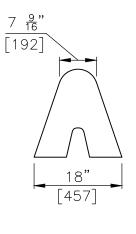
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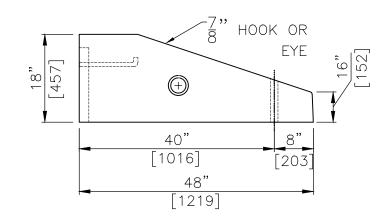


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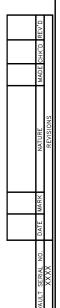
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DOWNTOWN P	BL	PVDT02
		SHEET 51 OF 79

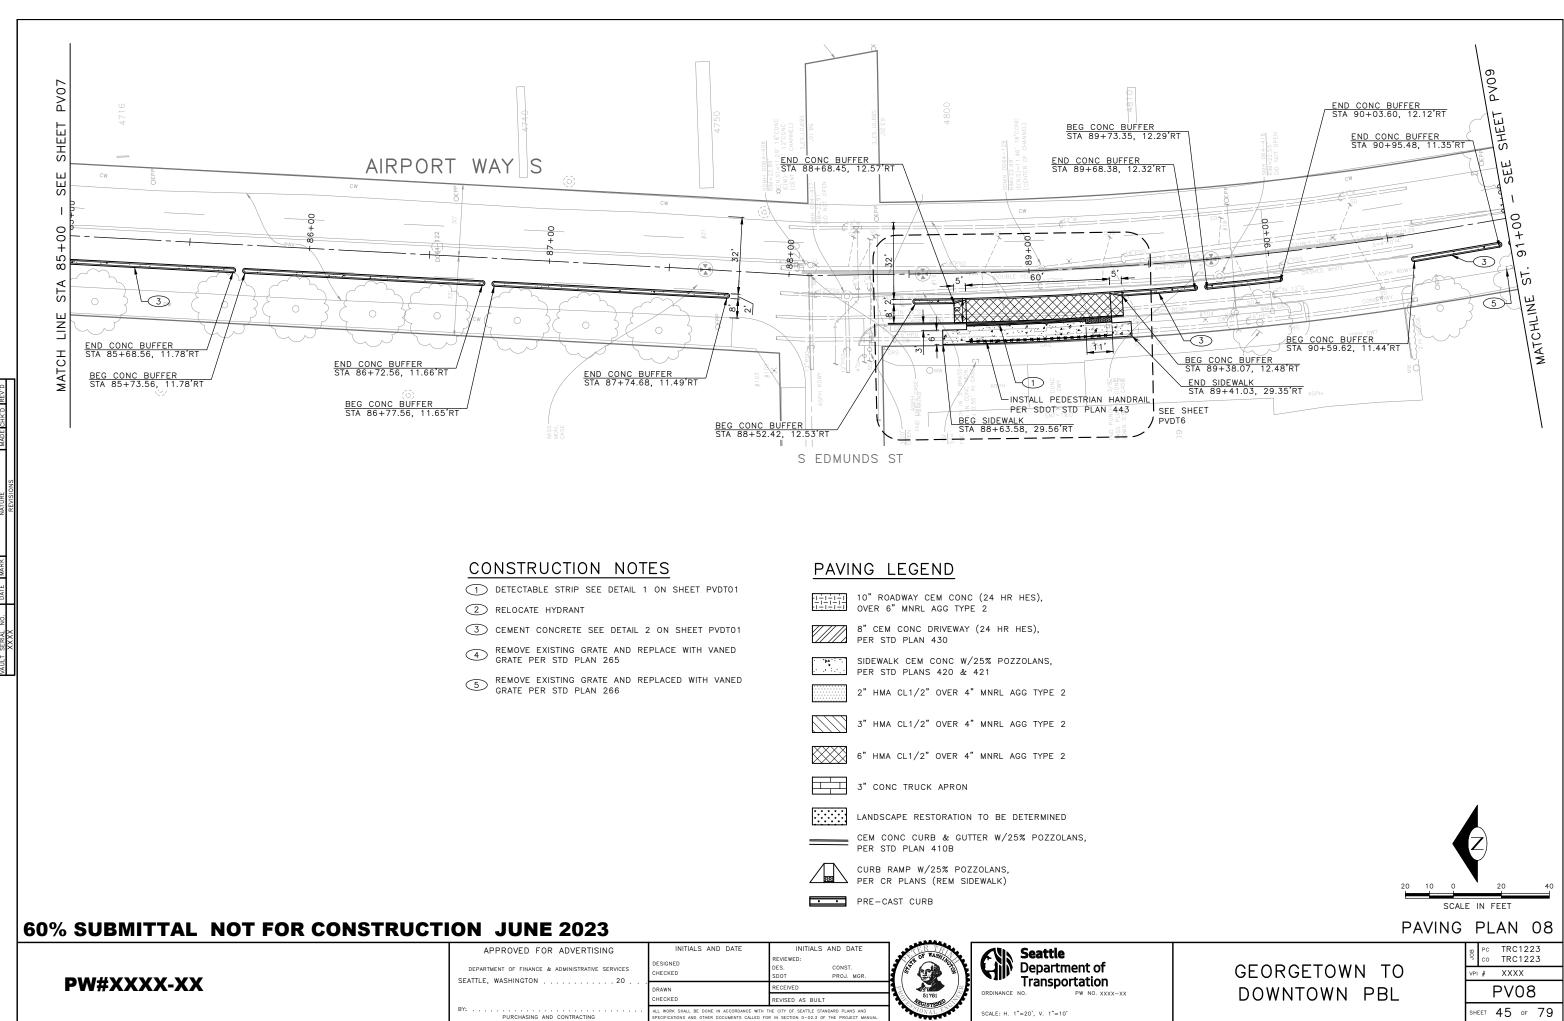PAVING DETAILS 02


- 3.18" BULLNOSE IS POURED WITH FIBRILATED FIBRE STRAND REINFORCED CONDRETE.
- 1.30Mpa @ 28 DAYS 2.CURB MAY BE PRODUCED WITHOUT HOOK & EYE CONNECTIONS.

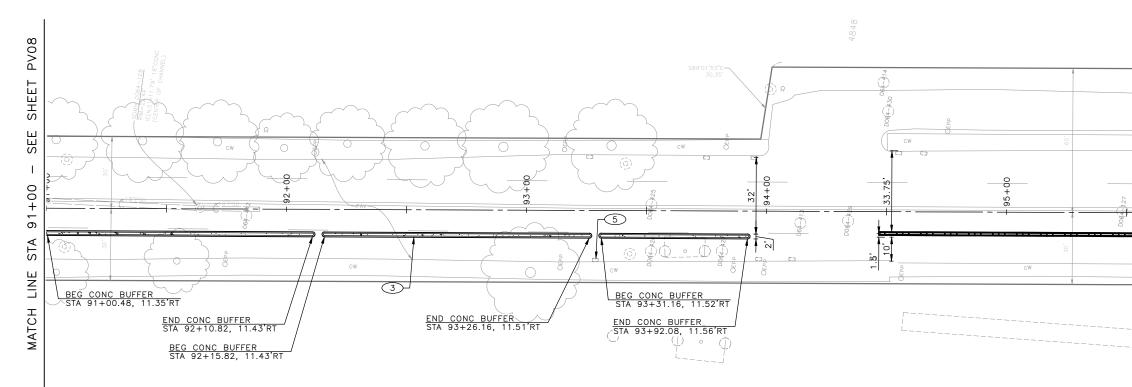
<u>NOTES</u>



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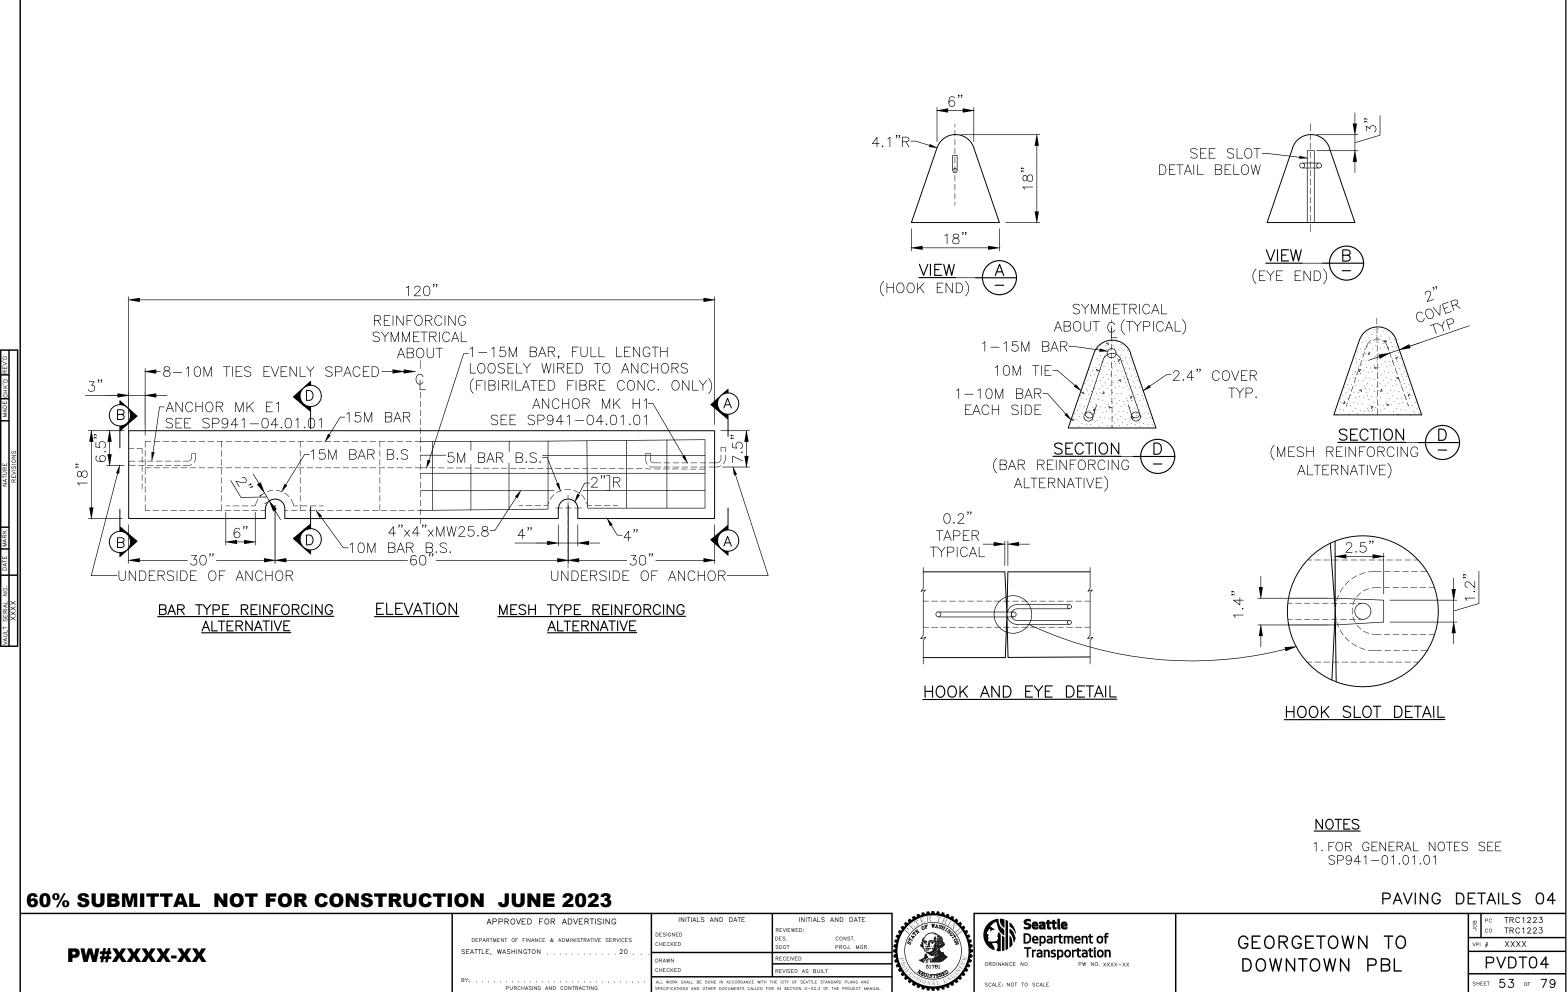


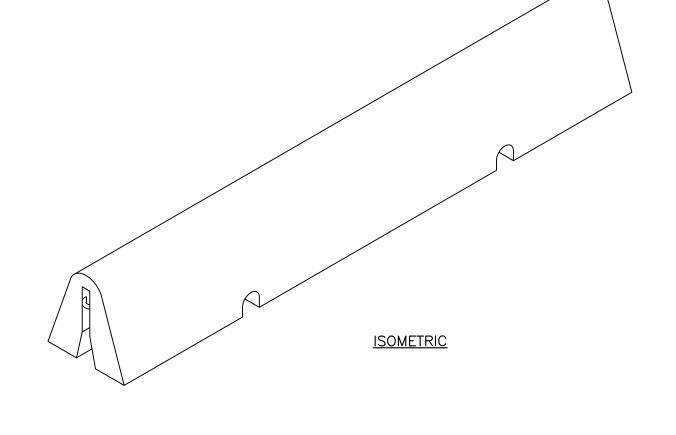

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30Mpg @ 28 DAYS
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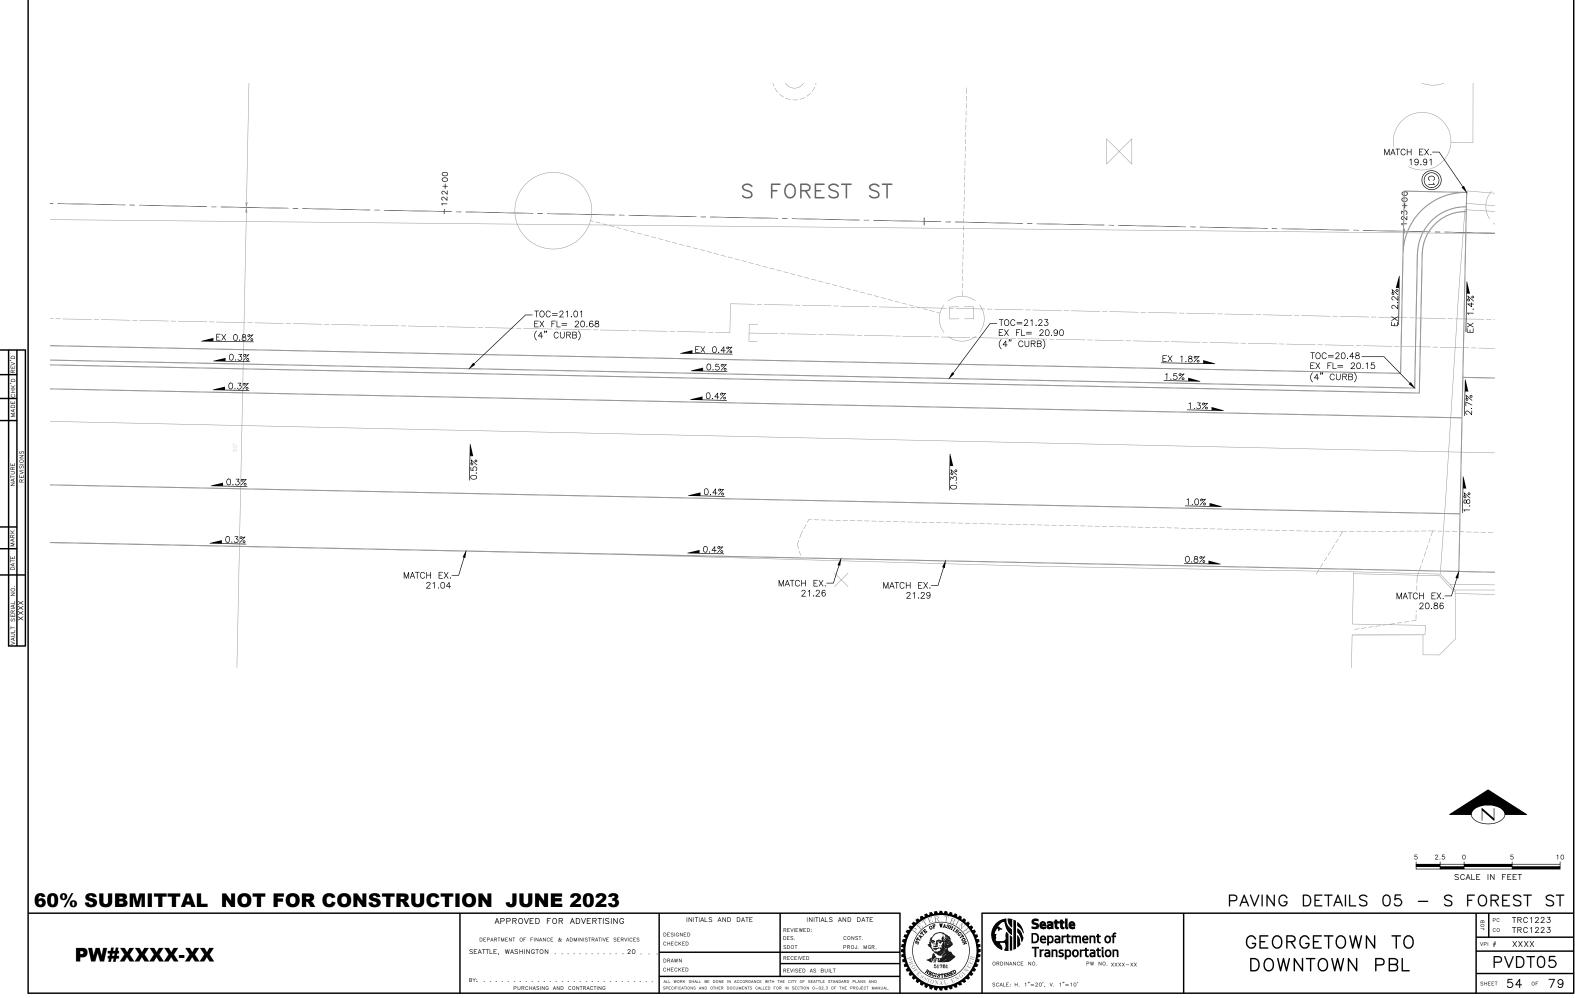
<u>NOTES</u>

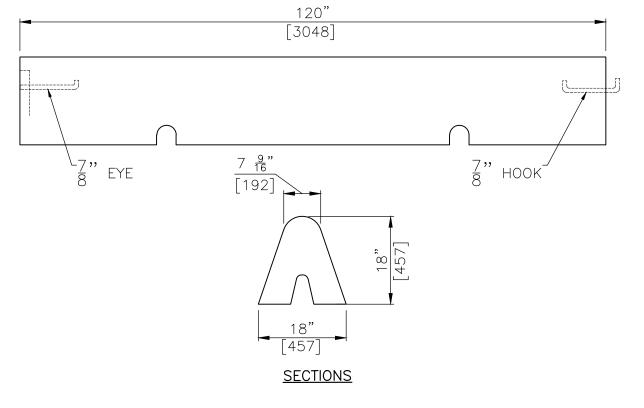

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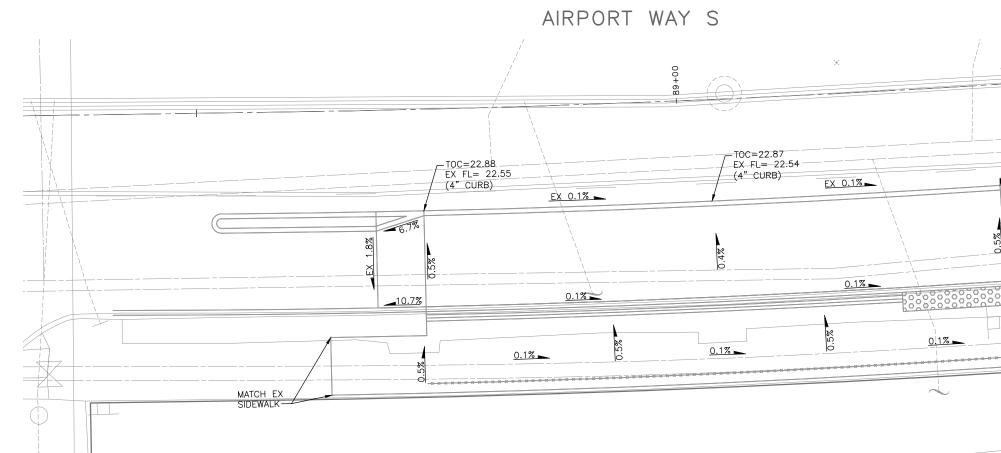
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	APPROVED FOR ADVERTISING DEPARTMENT OF FINANCE & ADMINISTRATIVE SERVICES SEATTLE, WASHINGTON	INITIALS AND DATE DESIGNED CHECKED	INITIALS AND DATE REVIEWED: DES. CONST. SDOT PROJ. MGR.		Seattle Department of Transportation
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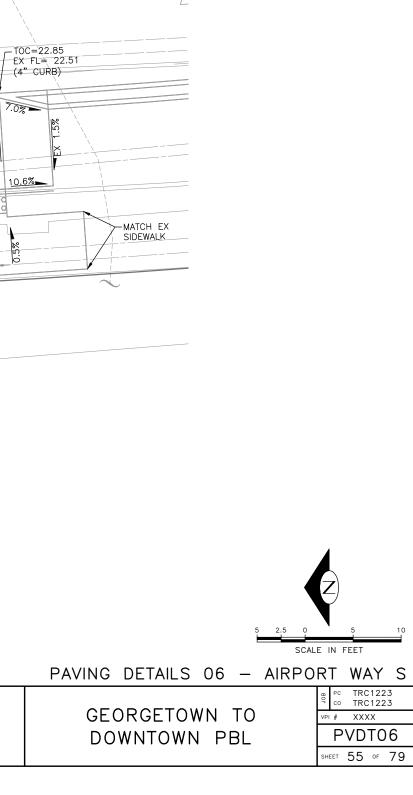
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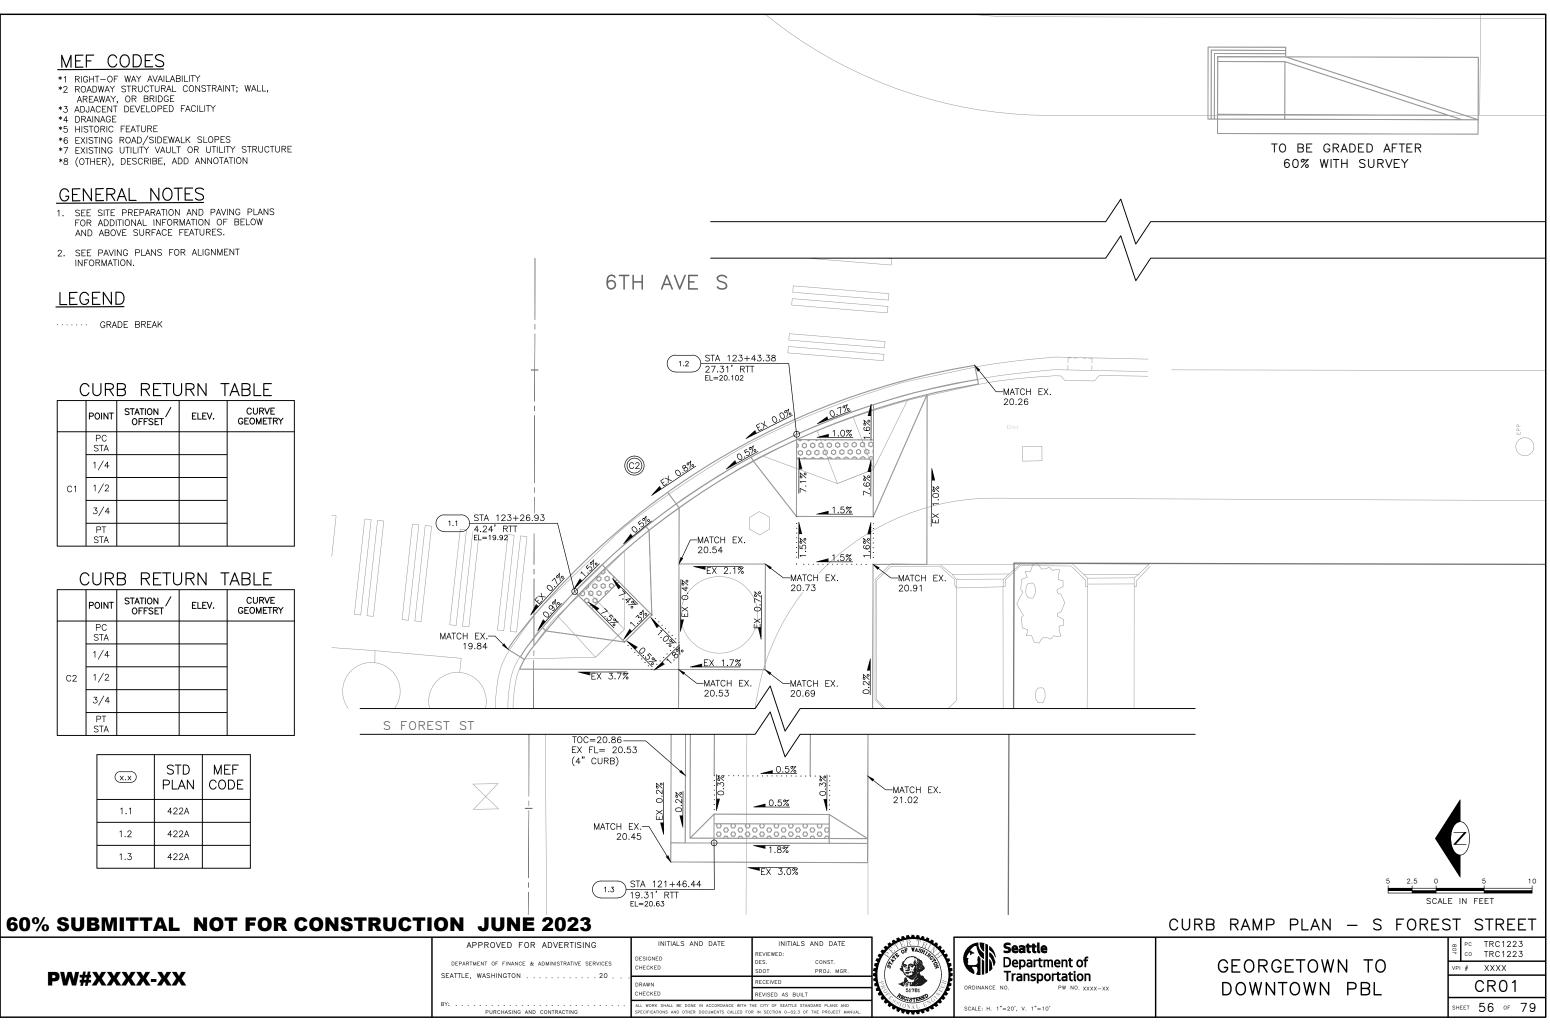
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- FOR ADDITIONAL INFORMATION OF BELOW
- INFORMATION.





CURB RETURN TABLE

	POINT	STATION / OFFSET	ELEV.	CURVE GEOMETRY
	PC STA			
	1/4			
С3	1/2			
	3/4			
	PT STA			

CURB RETURN TABLE

<u>``</u>	2013			
	POINT	STATION / OFFSET	ELEV.	CURVE GEOMETRY
	PC STA			
	1/4			
C4	1/2			
	3/4			
	PT STA			

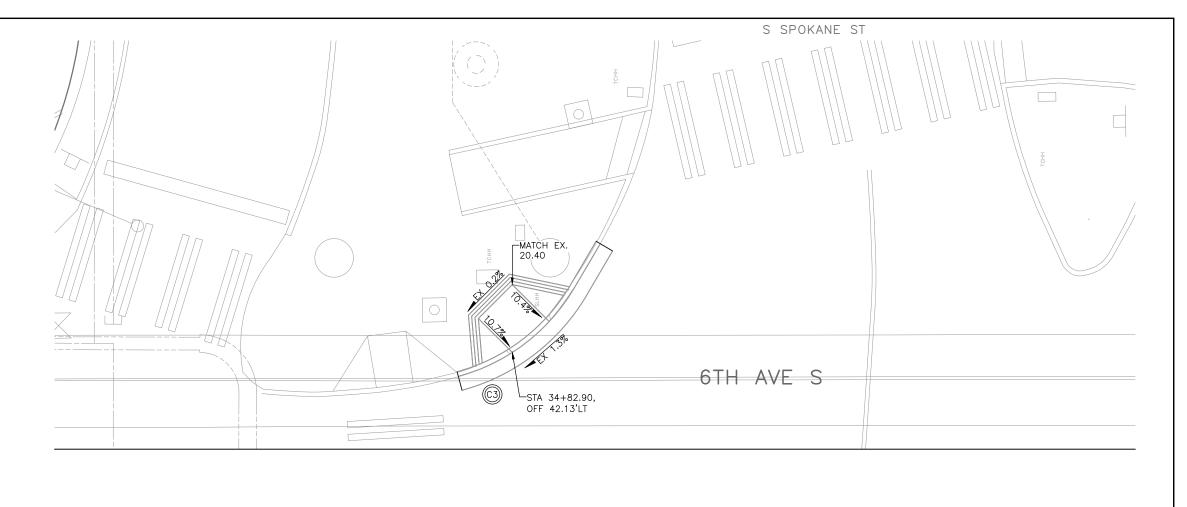

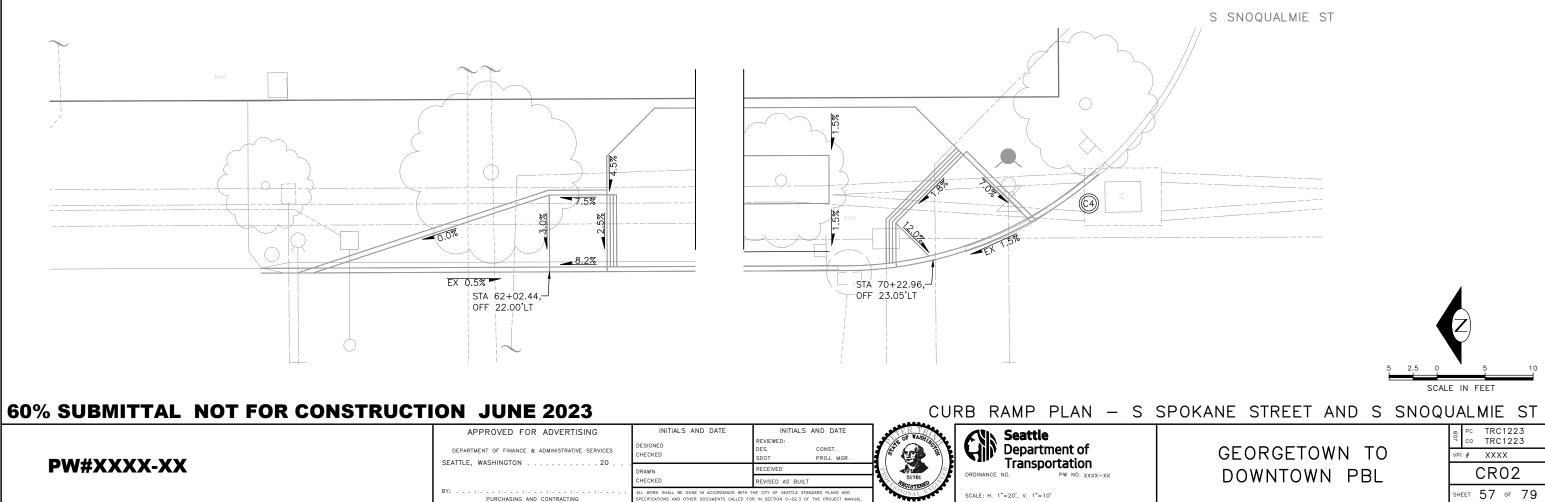

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CURB RETURN TABLE

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	PC STA			
	1/4			
C5	1/2			
	3/4			
	PT STA			

CURB RETURN TABLE

	POINT	STATION / OFFSET	ELEV.	CURVE GEOMETRY
	PC STA			
	1/4			
C6	1/2			
	3/4			
	PT STA			

CURB RETURN TABLE

	POINT	STATION / OFFSET	ELEV.	CURVE GEOMETRY
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C7	1/2			
	PRC			
С8	1/2			
	PT STA			
			· · · · · ·	

(x.x)	STD PLAN	MEF CODE	
2.1	422E		

MEF CODES

*1 RIGHT-OF WAY AVAILABILITY *2 ROADWAY STRUCTURAL CONSTRAINT; WALL, AREAWAY, OR BRIDGE *3 ADJACENT DEVELOPED FACILITY

(C5)

4.1%

2.3%

2.0%

0.5%

0.5%

0.5%

1.0%

- *4 DRAINAGE
 *5 HISTORIC FEATURE
 *6 EXISTING ROAD/SIDEWALK SLOPES
 *7 EXISTING UTILITY VAULT OR UTILITY STRUCTURE
 *8 (OTHER), DESCRIBE, ADD ANNOTATION

GENERAL NOTES

- 1. SEE SITE PREPARATION AND PAVING PLANS FOR ADDITIONAL INFORMATION OF BELOW AND ABOVE SURFACE FEATURES.
- 2. SEE PAVING PLANS FOR ALIGNMENT INFORMATION.

LEGEND


GRADE BREAK

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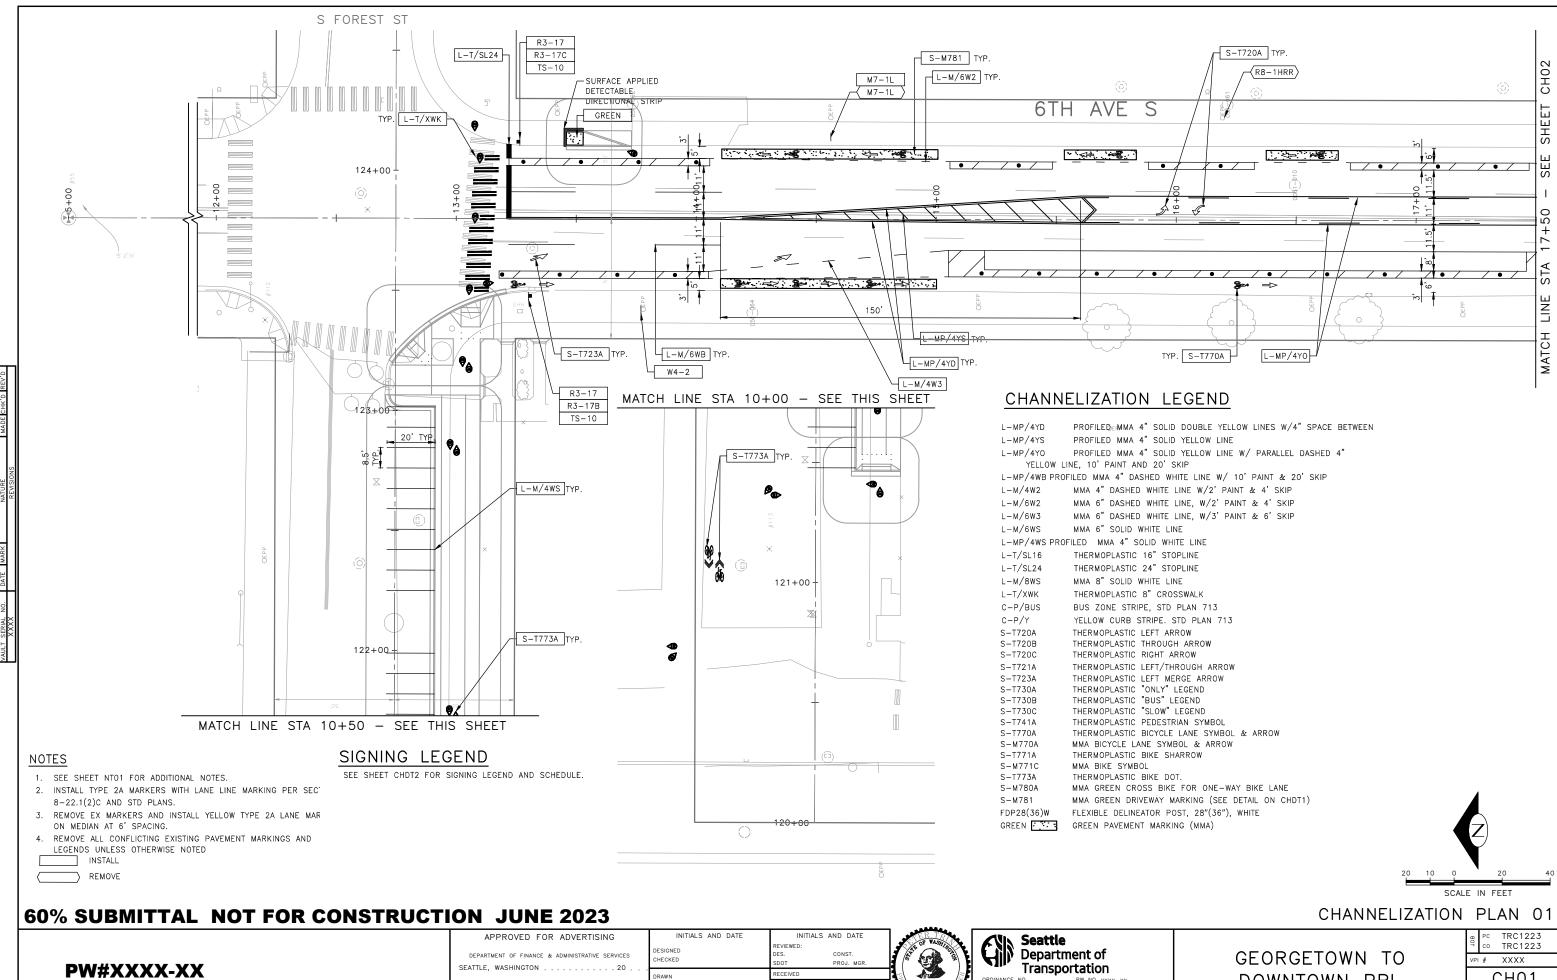
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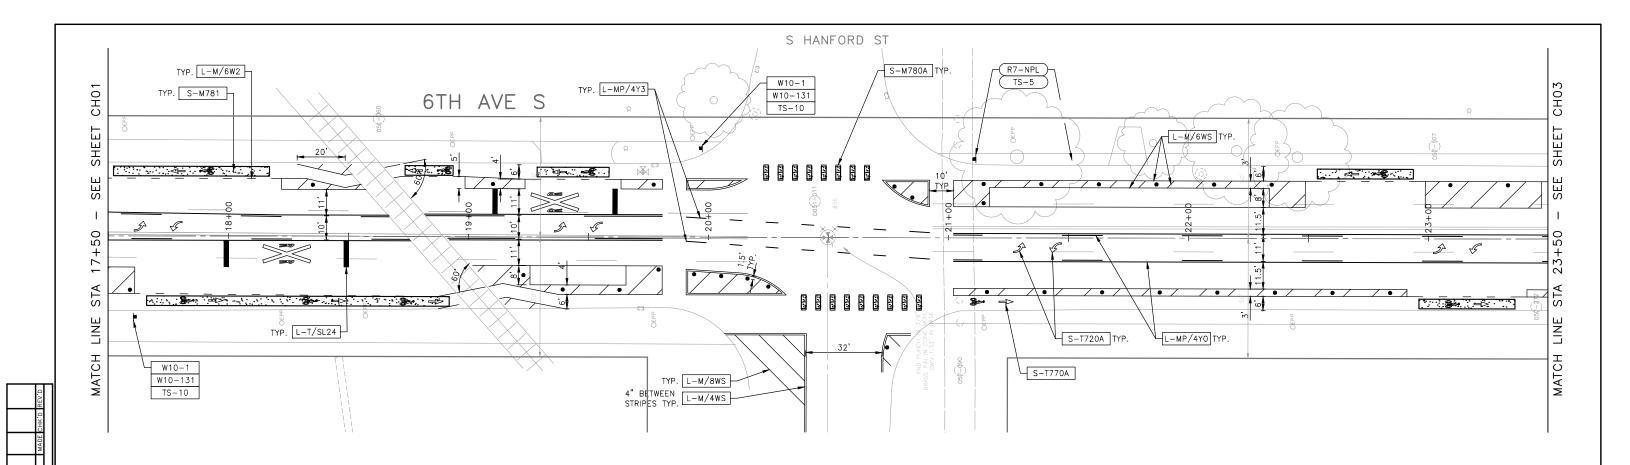
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TRC1223-JUNE 01

PW NO. XXXX-XX

SCALE: AS NOTED

CH01 DOWNTOWN PBL SHEET 60 OF 79

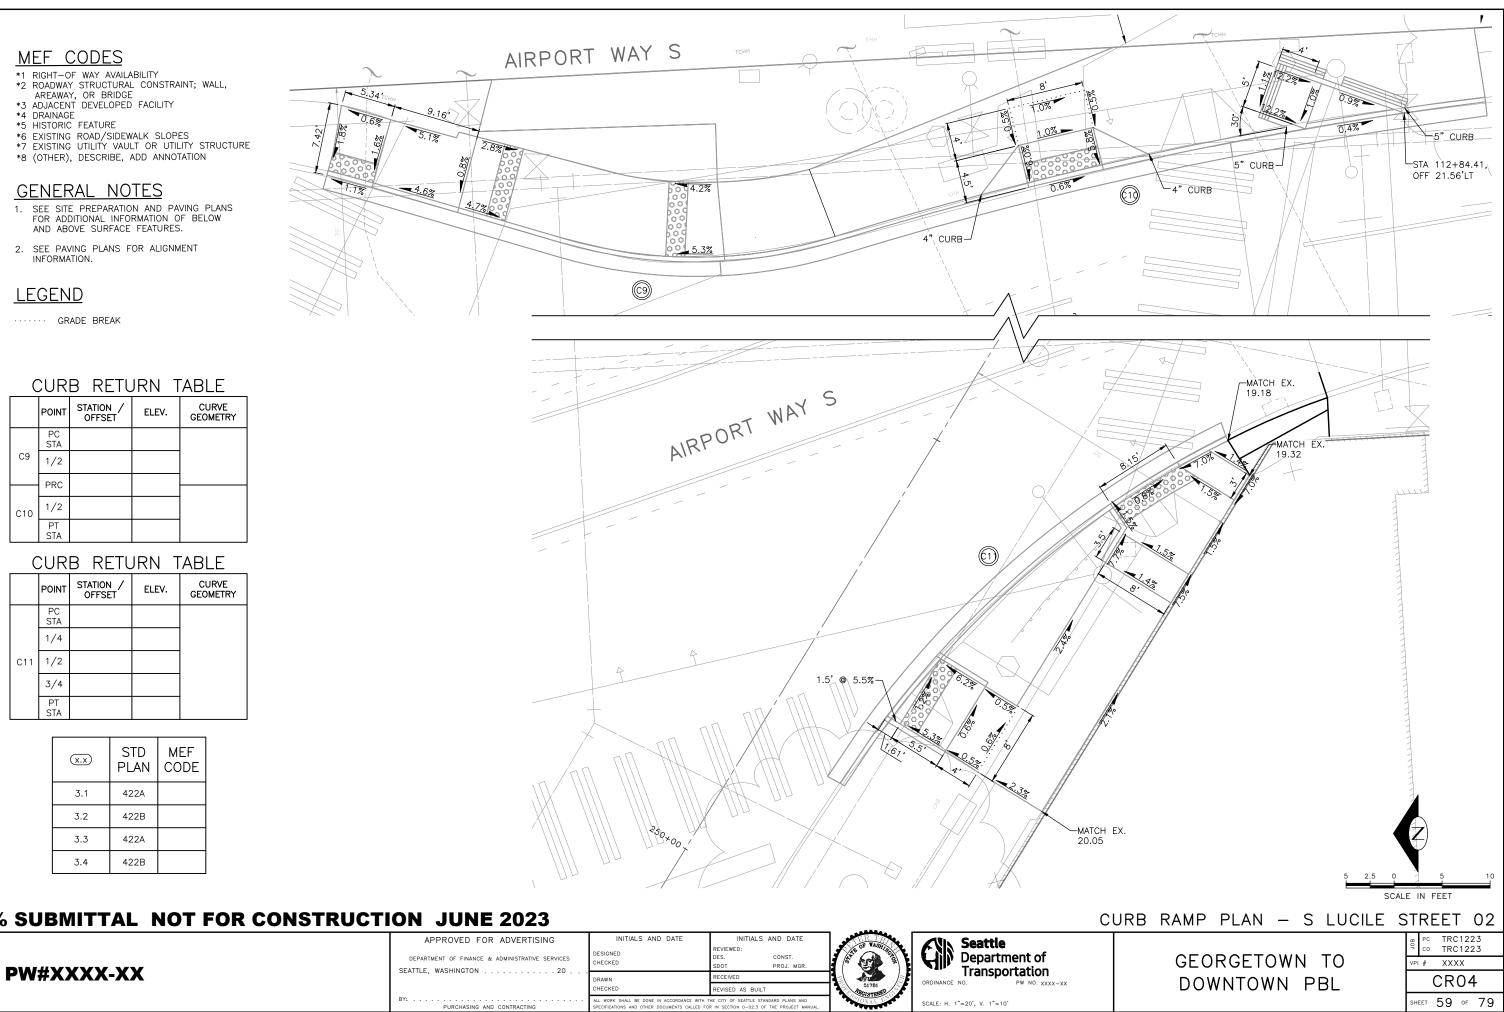

L-MP/4YD	PROFILEDERMMA 4" SOLID DOUBLE YELLOW LINES W/4" SPACE BETWEEN
L-MP/4YS	PROFILED MMA 4" SOLID YELLOW LINE
L-MP/4YO	PROFILED MMA 4" SOLID YELLOW LINE W/ PARALLEL DASHED 4"
YELLOW LIN	NE, 10' PAINT AND 20' SKIP
L-MP/4WB PROF	ILED MMA 4" DASHED WHITE LINE W/ 10' PAINT & 20' SKIP
L-M/4W2	MMA 4" DASHED WHITE LINE W/2' PAINT & 4' SKIP
L-M/6W2	MMA 6" DASHED WHITE LINE, W/2' PAINT & 4' SKIP
L-M/6W3	MMA 6" DASHED WHITE LINE, W/3' PAINT & 6' SKIP
L-M/6WS	MMA 6" SOLID WHITE LINE
L-MP/4WS PROF	ILED MMA 4" SOLID WHITE LINE
L-T/SL16	THERMOPLASTIC 16" STOPLINE
L-T/SL24	THERMOPLASTIC 24" STOPLINE
L-M/8WS	MMA 8" SOLID WHITE LINE
L-T/XWK	THERMOPLASTIC 8" CROSSWALK
C-P/BUS	BUS ZONE STRIPE, STD PLAN 713
C-P/Y	YELLOW CURB STRIPE. STD PLAN 713

CHANNELIZATION LEGEND (CON'T)

S-T720A	THERMOPLASTIC LEFT ARROW
S-T720B	THERMOPLASTIC THROUGH ARROW
S-T720C	THERMOPLASTIC RIGHT ARROW
S-T721A	THERMOPLASTIC LEFT/THROUGH ARROW
S-T723A	THERMOPLASTIC LEFT MERGE ARROW
S-T730A	THERMOPLASTIC "ONLY" LEGEND
S-T730B	THERMOPLASTIC "BUS" LEGEND
S-T730C	THERMOPLASTIC "SLOW" LEGEND
S-T741A	THERMOPLASTIC PEDESTRIAN SYMBOL
S-T770A	THERMOPLASTIC BICYCLE LANE SYMBOL & ARROW
S-M770A	MMA BICYCLE LANE SYMBOL & ARROW
S-T771A	THERMOPLASTIC BIKE SHARROW
S-M771C	MMA BIKE SYMBOL
S-T773A	THERMOPLASTIC BIKE DOT.
S-M780A	MMA GREEN CROSS BIKE FOR ONE-WAY BIKE LANE
S-M781	MMA GREEN DRIVEWAY MARKING (SEE DETAIL ON CHDT1)
FDP28(36)W	FLEXIBLE DELINEATOR POST, 28"(36"), WHITE
,	
GREEN	GREEN PAVEMENT MARKING (MMA)

SIGNING LEGEND


SEE SHEET CHDT2 FOR SIGNING LEGEND AND SCHEDULE.


60% SUBMITTAL NOT FOR CONSTRUCTION JUNE 2023

	APPROVED FOR ADVERTISING	INITIALS AND DATE	INITIALS AND DATE	A SER TRAN	
	DEPARTMENT OF FINANCE & ADMINISTRATIVE SERVICES SEATTLE, WASHINGTON	DESIGNED CHECKED	REVIEWED: DES. CONST. SDOT PROJ. MGR.		Department of
PW#XXXX-XX		DRAWN			
		CHECKED	REVISED AS BUILT	51781 PEGISTEEED	
	BY:	ALL WORK SHALL BE DONE IN ACCORDANCE WITH SPECIFICATIONS AND OTHER DOCUMENTS CALLED FO		SSIONAL SN	SCALE: AS NOTED

NOTES

- 1. SEE SHEET NTO1 FOR ADDITIONAL NOTES.
- INSTALL TYPE 2A MARKERS WITH LANE LINE MARKING PER SECT 8-22.1(2)C AND STD PLANS.
- REMOVE EX MARKERS AND INSTALL YELLOW TYPE 2A LANE MARI ON MEDIAN AT 6' SPACING.
- 4. REMOVE ALL CONFLICTING EXISTING PAVEMENT MARKINGS AND LEGENDS UNLESS OTHERWISE NOTED
- INSTALL
- REMOVE
 - RELOCATE/MAINTAIN

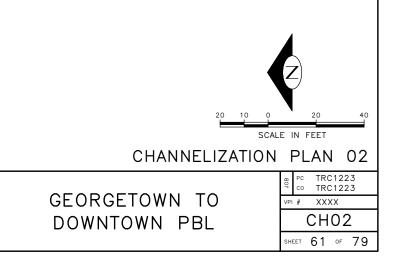

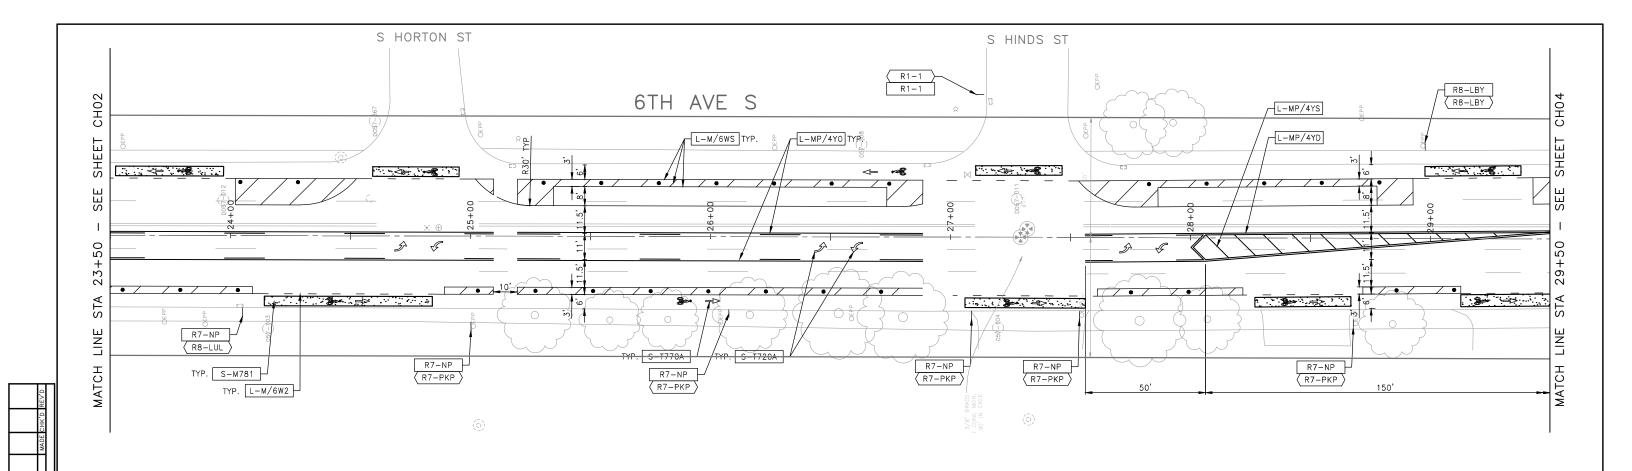

THERMOPLASTIC LEFT ARROW

S-T720A

L-MP/4YD	PROFILEDERMMA 4" SOLID DOUBLE YELLOW LINES W/4" SPACE BETWEEN
L-MP/4YS	PROFILED MMA 4" SOLID YELLOW LINE
L-MP/4YO	PROFILED MMA 4" SOLID YELLOW LINE W/ PARALLEL DASHED 4"
YELLOW LI	NE, 10' PAINT AND 20' SKIP
L-MP/4WB PROF	ILED MMA 4" DASHED WHITE LINE W/ 10' PAINT & 20' SKIP
L-M/4W2	MMA 4" DASHED WHITE LINE W/2' PAINT & 4' SKIP
L-M/6W2	MMA 6" DASHED WHITE LINE, W/2' PAINT & 4' SKIP
L-M/6W3	MMA 6" DASHED WHITE LINE, W/3' PAINT & 6' SKIP
L-M/6WS	MMA 6" SOLID WHITE LINE
L-MP/4WS PROF	ILED MMA 4" SOLID WHITE LINE
L-T/SL16	THERMOPLASTIC 16" STOPLINE
L-T/SL24	THERMOPLASTIC 24" STOPLINE
L-M/8WS	MMA 8" SOLID WHITE LINE
L-T/XWK	THERMOPLASTIC 8" CROSSWALK
C-P/BUS	BUS ZONE STRIPE, STD PLAN 713
C-P/Y	YELLOW CURB STRIPE. STD PLAN 713
	L-MP/4YS L-MP/4YO YELLOW LII L-MP/4WB PROF L-M/4W2 L-M/6W2 L-M/6W3 L-M/6WS L-M/6WS L-M/4WS PROF L-T/SL16 L-T/SL24 L-M/8WS L-T/XWK C-P/BUS

S-T720B	THERMOPLASTIC THROUGH ARROW
S-T720C	THERMOPLASTIC RIGHT ARROW
S-T721A	THERMOPLASTIC LEFT/THROUGH ARROW
S-T723A	THERMOPLASTIC LEFT MERGE ARROW
S-T730A	THERMOPLASTIC "ONLY" LEGEND
S-T730B	THERMOPLASTIC "BUS" LEGEND
S-T730C	THERMOPLASTIC "SLOW" LEGEND
S-T741A	THERMOPLASTIC PEDESTRIAN SYMBOL
S-T770A	THERMOPLASTIC BICYCLE LANE SYMBOL & ARROW
S-M770A	MMA BICYCLE LANE SYMBOL & ARROW
S-T771A	THERMOPLASTIC BIKE SHARROW
S-M771C	MMA BIKE SYMBOL
S-T773A	THERMOPLASTIC BIKE DOT.
S-M780A	MMA GREEN CROSS BIKE FOR ONE-WAY BIKE LANE
S-M781	MMA GREEN DRIVEWAY MARKING (SEE DETAIL ON CHDT1)
FDP28(36)W	FLEXIBLE DELINEATOR POST, 28"(36"), WHITE
GREEN	GREEN PAVEMENT MARKING (MMA)
GREEN	GREEN PAVEMENT MARKING (MMA)

SIGNING LEGEND

SEE SHEET CHDT2 FOR SIGNING LEGEND AND SCHEDULE.


60% SUBMITTAL NOT FOR CONSTRUCTION JUNE 2023


	DEPARTMENT OF FINANCE & ADMINISTRATIVE SERVICES SEATTLE, WASHINGTON	INITIALS AND DATE DESIGNED CHECKED	INITIALS AND DATE REVIEWED: DES. CONST. SDOT PROJ. MGR.		Seattle Department of Transportation ORDINANCE NO. PW NO. XXXX-XX
PW#XXXX-XX		DRAWN CHECKED	RECEIVED REVISED AS BUILT		
	BY:	ALL WORK SHALL BE DONE IN ACCORDANCE WITH T SPECIFICATIONS AND OTHER DOCUMENTS CALLED FO		SYONAL SN	SCALE: AS NOTED

NOTES

- 1. SEE SHEET NTO1 FOR ADDITIONAL NOTES.
- 2. INSTALL TYPE 2A MARKERS WITH LANE LINE MARKING PER SECT 8-22.1(2)C AND STD PLANS.
- 3. REMOVE EX MARKERS AND INSTALL YELLOW TYPE 2A LANE MARI ON MEDIAN AT 6' SPACING.
- 4. REMOVE ALL CONFLICTING EXISTING PAVEMENT MARKINGS AND LEGENDS UNLESS OTHERWISE NOTED
- INSTALL
- REMOVE

RELOCATE/MAINTAIN

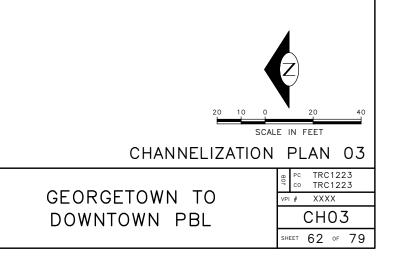

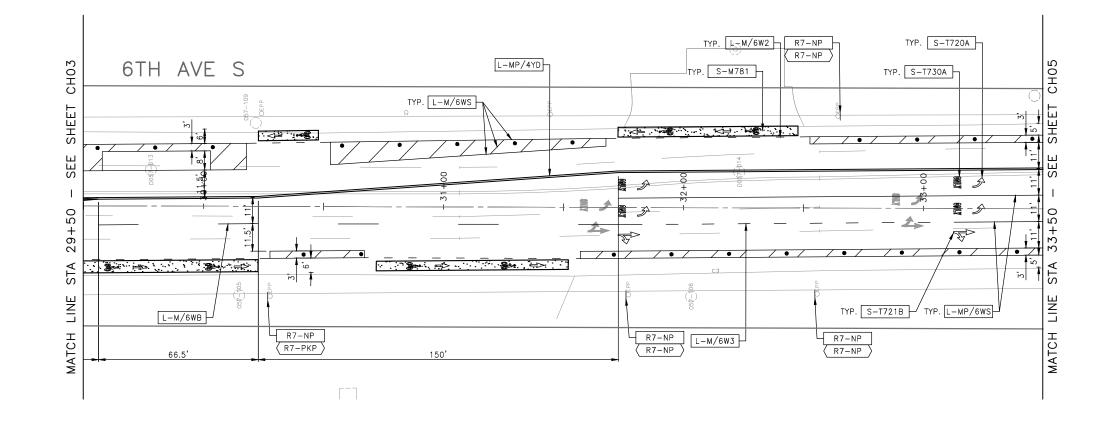

L-MP/4YD	PROFILEDEMMA 4" SOLID DOUBLE YELLOW LINES W/4" SPACE BETWEEN
L-MP/4YS	PROFILED MMA 4" SOLID YELLOW LINE
L-MP/4YO	PROFILED MMA 4" SOLID YELLOW LINE W/ PARALLEL DASHED 4"
YELLOW LI	NE, 10' PAINT AND 20' SKIP
L-MP/4WB PROF	ILED MMA 4" DASHED WHITE LINE W/ 10' PAINT & 20' SKIP
L-M/4W2	MMA 4" DASHED WHITE LINE W/2' PAINT & 4' SKIP
L-M/6W2	MMA 6" DASHED WHITE LINE, W/2' PAINT & 4' SKIP
L-M/6W3	MMA 6" DASHED WHITE LINE, W/3' PAINT & 6' SKIP
L-M/6WS	MMA 6" SOLID WHITE LINE
L-MP/4WS PROF	ILED MMA 4" SOLID WHITE LINE
L-T/SL16	THERMOPLASTIC 16" STOPLINE
L-T/SL24	THERMOPLASTIC 24" STOPLINE
L-M/8WS	MMA 8" SOLID WHITE LINE
L-T/XWK	THERMOPLASTIC 8" CROSSWALK
C-P/BUS	BUS ZONE STRIPE, STD PLAN 713
C-P/Y	YELLOW CURB STRIPE. STD PLAN 713

S-T720A	THERMOPLASTIC LEFT ARROW
S-T7208	THERMOPLASTIC THROUGH ARROW
S-T720D	THERMOPLASTIC RIGHT ARROW
S-T721A	THERMOPLASTIC LEFT/THROUGH ARROW
S-T723A	THERMOPLASTIC LEFT MERGE ARROW
S-T730A	THERMOPLASTIC "ONLY" LEGEND
S-T730B	THERMOPLASTIC "BUS" LEGEND
S-T730C	THERMOPLASTIC "SLOW" LEGEND
S-T741A	THERMOPLASTIC PEDESTRIAN SYMBOL
S-T770A	THERMOPLASTIC BICYCLE LANE SYMBOL & ARROW
S-M770A	MMA BICYCLE LANE SYMBOL & ARROW
S-T771A	THERMOPLASTIC BIKE SHARROW
S-M771C	MMA BIKE SYMBOL
S-T773A	THERMOPLASTIC BIKE DOT.
S-M780A	MMA GREEN CROSS BIKE FOR ONE-WAY BIKE LANE
S-M781	MMA GREEN DRIVEWAY MARKING (SEE DETAIL ON CHDT1)
FDP28(36)W	FLEXIBLE DELINEATOR POST, 28"(36"), WHITE
GREEN	GREEN PAVEMENT MARKING (MMA)

SIGNING LEGEND

SEE SHEET CHDT2 FOR SIGNING LEGEND AND SCHEDULE.


60% SUBMITTAL NOT FOR CONSTRUCTION JUNE 2023


	DEPARTMENT OF FINANCE & ADMINISTRATIVE SERVICES SEATTLE, WASHINGTON	INITIALS AND DATE DESIGNED CHECKED	INITIALS AND DATE REVIEWED: DES. CONST. SDOT PROJ. MGR.		Seattle Department of Transportation
PW#XXXX-XX		DRAWN	RECEIVED		
		CHECKED	REVISED AS BUILT	PEGISTERED	
	BY:	ALL WORK SHALL BE DONE IN ACCORDANCE WITH T SPECIFICATIONS AND OTHER DOCUMENTS CALLED FO		NONAL ES	SCALE: AS NOTED

NOTES

- 1. SEE SHEET NTO1 FOR ADDITIONAL NOTES.
- 2. INSTALL TYPE 2A MARKERS WITH LANE LINE MARKING PER SECT $8\!-\!22.1(2)C$ and STD plans.
- REMOVE EX MARKERS AND INSTALL YELLOW TYPE 2A LANE MARI ON MEDIAN AT 6' SPACING.
- 4. REMOVE ALL CONFLICTING EXISTING PAVEMENT MARKINGS AND LEGENDS UNLESS OTHERWISE NOTED
- INSTALL
- REMOVE

RELOCATE/MAINTAIN

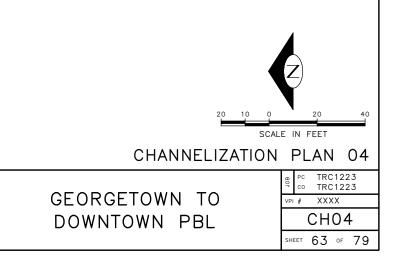

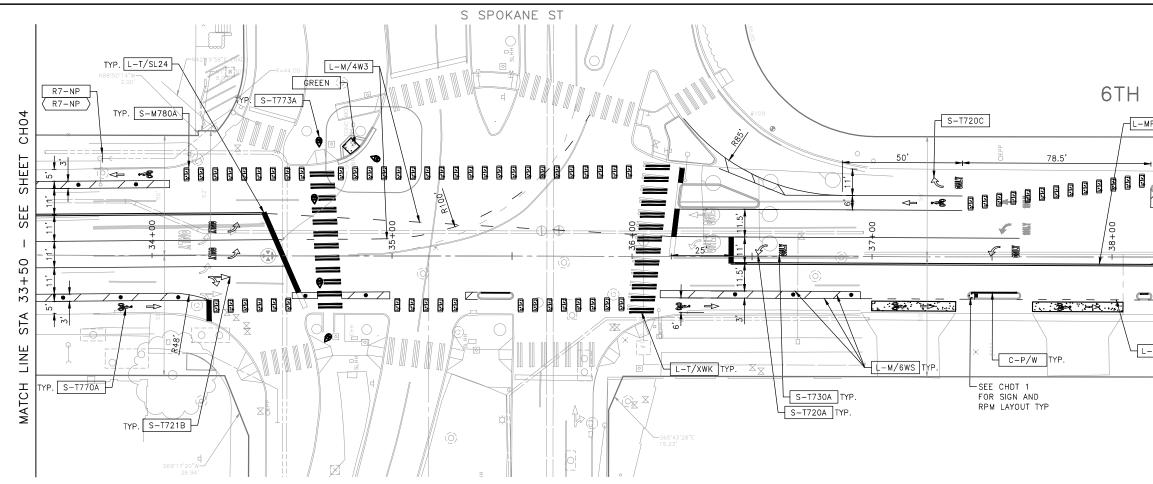

L-MP/4YD	PROFILEDEMMA 4" SOLID DOUBLE YELLOW LINES W/4" SPACE BETWEEN
L-MP/4YS	PROFILED MMA 4" SOLID YELLOW LINE
	PROFILED MMA 4" SOLID YELLOW LINE W/ PARALLEL DASHED 4" NE, 10' PAINT AND 20' SKIP
L-MP/4WB PROF	ILED MMA 4" DASHED WHITE LINE W/ 10' PAINT & 20' SKIP
L-M/4W2	MMA 4" DASHED WHITE LINE W/2' PAINT & 4' SKIP
L-M/6W2	MMA 6" DASHED WHITE LINE, W/2' PAINT & 4' SKIP
L-M/6W3	MMA 6" DASHED WHITE LINE, W/3' PAINT & 6' SKIP
L-M/6WS	MMA 6" SOLID WHITE LINE
L-MP/4WS PROF	ILED MMA 4" SOLID WHITE LINE
L-T/SL16	THERMOPLASTIC 16" STOPLINE
L-T/SL24	THERMOPLASTIC 24" STOPLINE
L-M/8WS	MMA 8" SOLID WHITE LINE
L-T/XWK	THERMOPLASTIC 8" CROSSWALK
C-P/BUS	BUS ZONE STRIPE, STD PLAN 713
C-P/Y	YELLOW CURB STRIPE. STD PLAN 713

CHANNELIZATION LEGEND (CON'T)


S-T720A	THERMOPLASTIC LEFT ARROW
S-T720B	THERMOPLASTIC THROUGH ARROW
S-T720C	THERMOPLASTIC RIGHT ARROW
S-T721A	THERMOPLASTIC LEFT/THROUGH ARROW
S-T723A	THERMOPLASTIC LEFT MERGE ARROW
S-T730A	THERMOPLASTIC "ONLY" LEGEND
S-T730B	THERMOPLASTIC "BUS" LEGEND
S-T730C	THERMOPLASTIC "SLOW" LEGEND
S-T741A	THERMOPLASTIC PEDESTRIAN SYMBOL
S-T770A	THERMOPLASTIC BICYCLE LANE SYMBOL & ARROW
S-M770A	MMA BICYCLE LANE SYMBOL & ARROW
S-⊤771A	THERMOPLASTIC BIKE SHARROW
S-M771C	MMA BIKE SYMBOL
S-T773A	THERMOPLASTIC BIKE DOT.
S-M780A	MMA GREEN CROSS BIKE FOR ONE-WAY BIKE LANE
S-M781	MMA GREEN DRIVEWAY MARKING (SEE DETAIL ON CHDT1)
FDP28(36)W	FLEXIBLE DELINEATOR POST, 28"(36"), WHITE
GREEN	GREEN PAVEMENT MARKING (MMA)
	ONELN FAVEMENT MANNING (MMA)


SIGNING LEGEND

SEE SHEET CHDT2 FOR SIGNING LEGEND AND SCHEDULE.

60% SUBMITTAL NOT FOR CONSTRUCTION JUNE 2023

	DEPARTMENT OF FINANCE & ADMINISTRATIVE SERVICES	INITIALS AND DATE DESIGNED CHECKED	INITIALS AND DATE REVIEWED: DES. CONST. SDOT PROJ. MGR.		Seattle Department of Transportation
PW#XXXX-XX	BY;	CHECKED	RECEIVED REVISED AS BUILT THE CITY OF SEATTLE STANDARD PLANS AND IN SECTION 0-02.3 OF THE PROJECT MANUAL.	SI781 SI781 MECISTERED OVAL	ORDINANCE NO. PW NO. XXXX-XX SCALE: AS NOTED

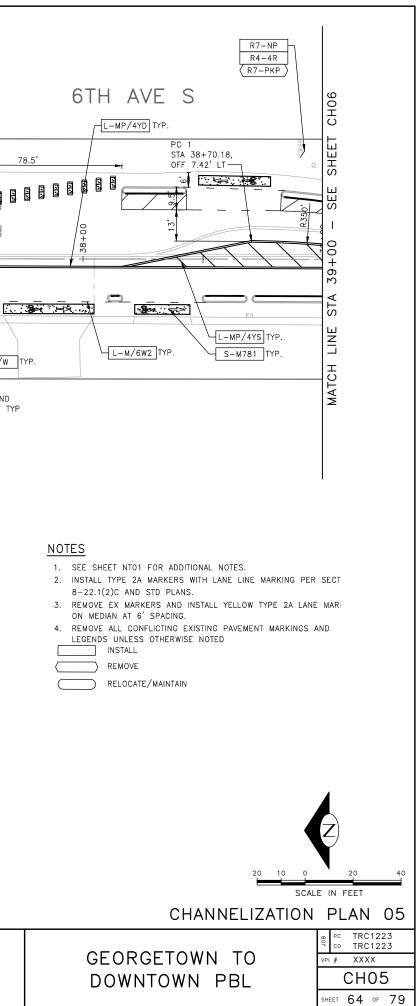

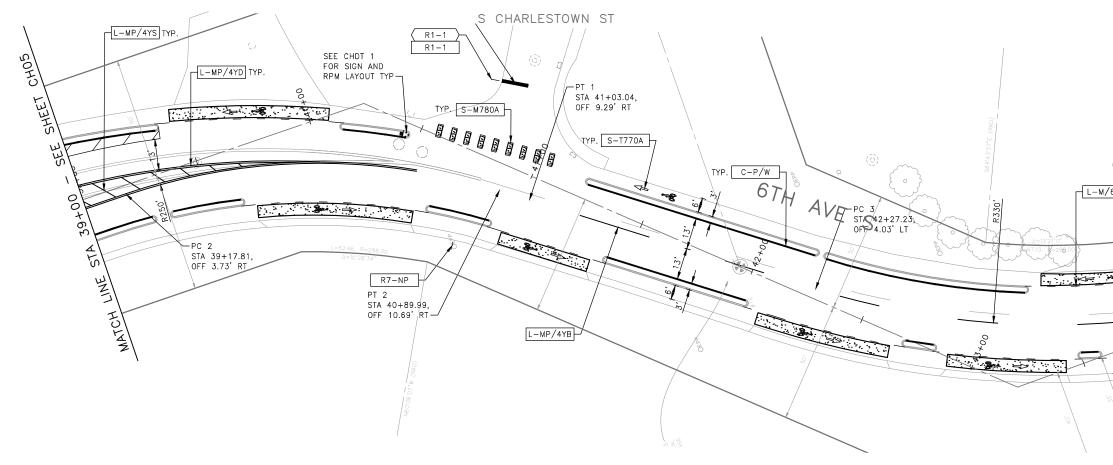

S-T720A

S-T720B

CHANNELIZATION LEGEND

CHANNELIZATION	LEGEND	(CON'T)
----------------	--------	---------

THERMOPLASTIC LEFT ARROW

THERMOPLASTIC THROUGH ARROW

L-MP/4YD	PROFILEDEMMA 4" SOLID DOUBLE YELLOW LINES W/4" SPACE BETWEEN
L-MP/4YS	PROFILED MMA 4" SOLID YELLOW LINE
	PROFILED MMA 4" SOLID YELLOW LINE W/ PARALLEL DASHED 4" NE, 10' PAINT AND 20' SKIP
	ILED MMA 4" DASHED WHITE LINE W/ 10' PAINT & 20' SKIP
L-M/4W2	MMA 4" DASHED WHITE LINE W/2' PAINT & 4' SKIP
L-M/6W2	MMA 6" DASHED WHITE LINE, W/2' PAINT & 4' SKIP
L-M/6W3	MMA 6" DASHED WHITE LINE, W/3' PAINT & 6' SKIP
L-M/6WS	MMA 6" SOLID WHITE LINE
L-MP/4WS PROF	ILED MMA 4" SOLID WHITE LINE
L-T/SL16	THERMOPLASTIC 16" STOPLINE
L-T/SL24	THERMOPLASTIC 24" STOPLINE
L-M/8WS	MMA 8" SOLID WHITE LINE
L-T/XWK	THERMOPLASTIC 8" CROSSWALK
C-P/BUS	BUS ZONE STRIPE, STD PLAN 713
C-P/Y	YELLOW CURB STRIPE. STD PLAN 713


S-T720C	THERMOPLASTIC RIGHT ARROW
S-T721A	THERMOPLASTIC LEFT/THROUGH ARROW
S-T723A	THERMOPLASTIC LEFT MERGE ARROW
S-T730A	THERMOPLASTIC "ONLY" LEGEND
S-T730B	THERMOPLASTIC "BUS" LEGEND
S-T730C	THERMOPLASTIC "SLOW" LEGEND
S-T741A	THERMOPLASTIC PEDESTRIAN SYMBOL
S-T770A	THERMOPLASTIC BICYCLE LANE SYMBOL & ARROW
S-M770A	MMA BICYCLE LANE SYMBOL & ARROW
S-T771A	THERMOPLASTIC BIKE SHARROW
S-M771C	MMA BIKE SYMBOL
S-T773A	THERMOPLASTIC BIKE DOT.
S-M780A	MMA GREEN CROSS BIKE FOR ONE-WAY BIKE LANE
S-M781	MMA GREEN DRIVEWAY MARKING (SEE DETAIL ON CHDT1)
FDP28(36)W	FLEXIBLE DELINEATOR POST, 28"(36"), WHITE
GREEN	GREEN PAVEMENT MARKING (MMA)


SIGNING LEGEND

SEE SHEET CHDT2 FOR SIGNING LEGEND AND SCHEDULE.

60% SUBMITTAL NOT FOR CONSTRUCTION JUNE 2023

	APPROVED FOR ADVERTISING	INITIALS AND DATE	INITIALS AND DATE	A SER TRANS	
	DEPARTMENT OF FINANCE & ADMINISTRATIVE SERVICES	DESIGNED CHECKED	REVIEWED: DES. CONST. SDOT PROJ. MGR.		Department of
PW#XXXX-XX	SEATTLE, WASHINGTON	DRAWN CHECKED	RECEIVED	51781	ORDINANCE NO. PW NO. XXXX-XX
	BY;	ALL WORK SHALL BE DONE IN ACCORDANCE WITH 1	REVISED AS BUILT	AEGISTERED	
	PURCHASING AND CONTRACTING	SPECIFICATIONS AND OTHER DOCUMENTS CALLED FO		CINA D	SCALE: AS NOTED

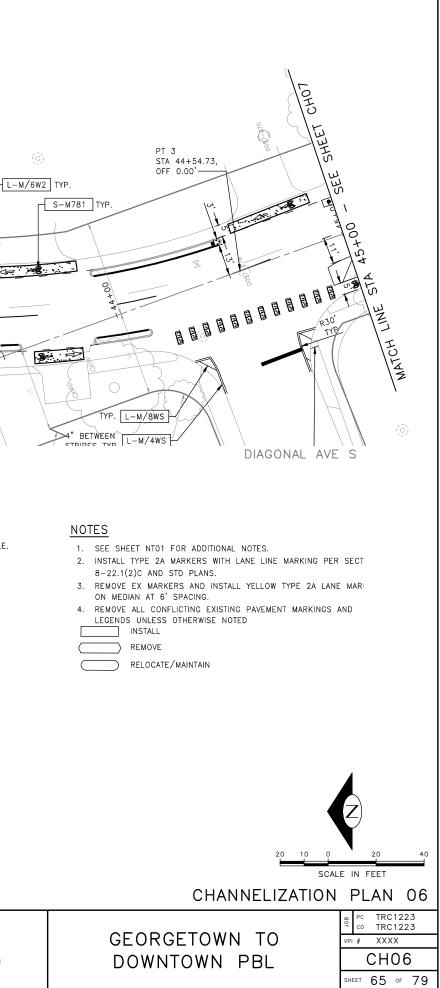

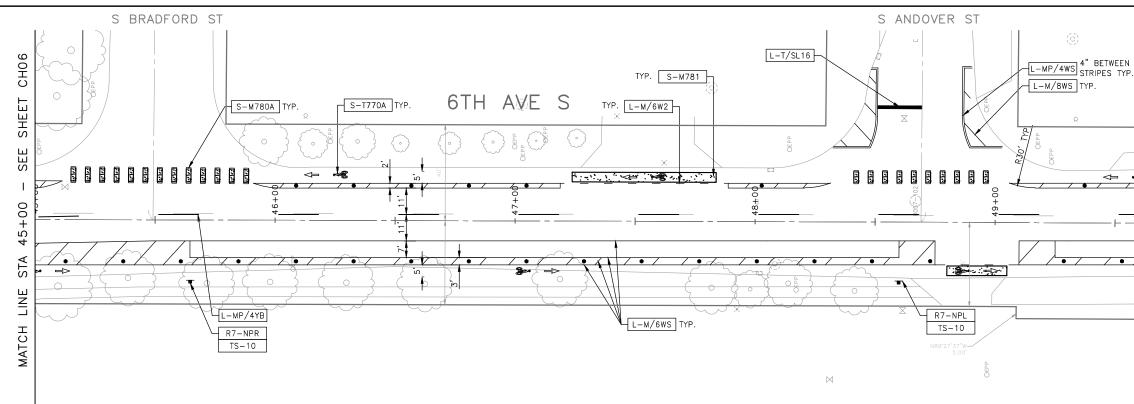

CHANNELIZATION LEGEND (CON'T)

L-MP/4YD	PROFILEDERMMA 4" SOLID DOUBLE YELLOW LINES W/4" SPACE BETWEEN
L-MP/4YS	PROFILED MMA 4" SOLID YELLOW LINE
L-MP/4YO	PROFILED MMA 4" SOLID YELLOW LINE W/ PARALLEL DASHED 4"
YELLOW LI	NE, 10' PAINT AND 20' SKIP
L-MP/4WB PROF	ILED MMA 4" DASHED WHITE LINE W/ 10' PAINT & 20' SKIP
L-M/4W2	MMA 4" DASHED WHITE LINE W/2' PAINT & 4' SKIP
L-M/6W2	MMA 6" DASHED WHITE LINE, W/2' PAINT & 4' SKIP
L−M/6W3	MMA 6" DASHED WHITE LINE, W/3' PAINT & 6' SKIP
L-M/6WS	MMA 6" SOLID WHITE LINE
L-MP/4WS PROF	ILED MMA 4" SOLID WHITE LINE
L-T/SL16	THERMOPLASTIC 16" STOPLINE
L-T/SL24	THERMOPLASTIC 24" STOPLINE
L-M/8WS	MMA 8" SOLID WHITE LINE
L-T/XWK	THERMOPLASTIC 8" CROSSWALK
C-P/BUS	BUS ZONE STRIPE, STD PLAN 713
C-P/Y	YELLOW CURB STRIPE. STD PLAN 713


S-T720A	THERMOPLASTIC LEFT ARROW
S-T720B	THERMOPLASTIC THROUGH ARROW
S-T720C	THERMOPLASTIC RIGHT ARROW
S-T721A	THERMOPLASTIC LEFT/THROUGH ARROW
S-T723A	THERMOPLASTIC LEFT MERGE ARROW
S-T730A	THERMOPLASTIC "ONLY" LEGEND
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S-M781	MMA GREEN DRIVEWAY MARKING (SEE DETAIL ON CHDT1)
FDP28(36)W	FLEXIBLE DELINEATOR POST, 28"(36"), WHITE
GREEN	GREEN PAVEMENT MARKING (MMA)

SIGNING LEGEND

SEE SHEET CHDT2 FOR SIGNING LEGEND AND SCHEDULE.

60% SUBMITTAL NOT FOR CONSTRUCTION JUNE 2023

	DEPARTMENT OF FINANCE & ADMINISTRATIVE SERVICES	INITIALS AND DATE DESIGNED CHECKED	INITIALS AND DATE REVIEWED: DES. CONST. SDOT PROJ. MGR.		Seattle Department of
V#XXXX-XX	,	DRAWN CHECKED	RECEIVED REVISED AS BUILT	51781 MCGISTERED	ORDINANCE NO. PW NO. XXXX-XX
	BY:PURCHASING AND CONTRACTING	ALL WORK SHALL BE DONE IN ACCORDANCE WITH T SPECIFICATIONS AND OTHER DOCUMENTS CALLED FO		VONAL ST	SCALE: AS NOTED

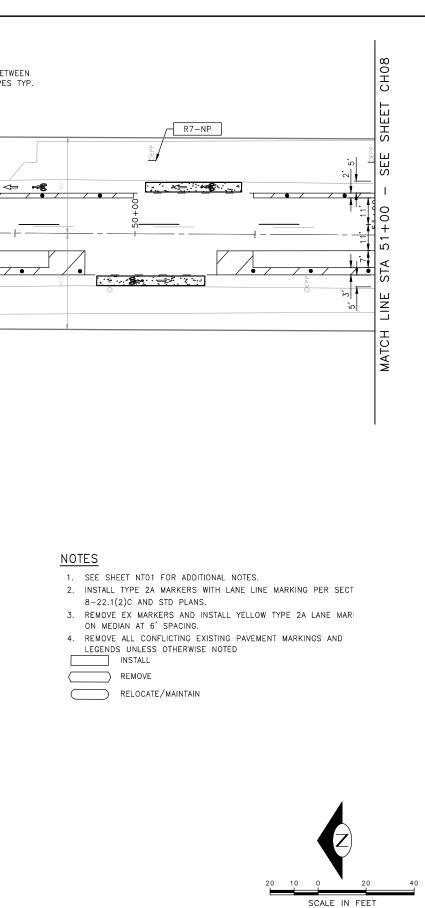

CHANNELIZATION PLAN 07

TRC1223 TRC1223


CH07

SHEET 66 OF 79

PC CO

VPI # XXXX



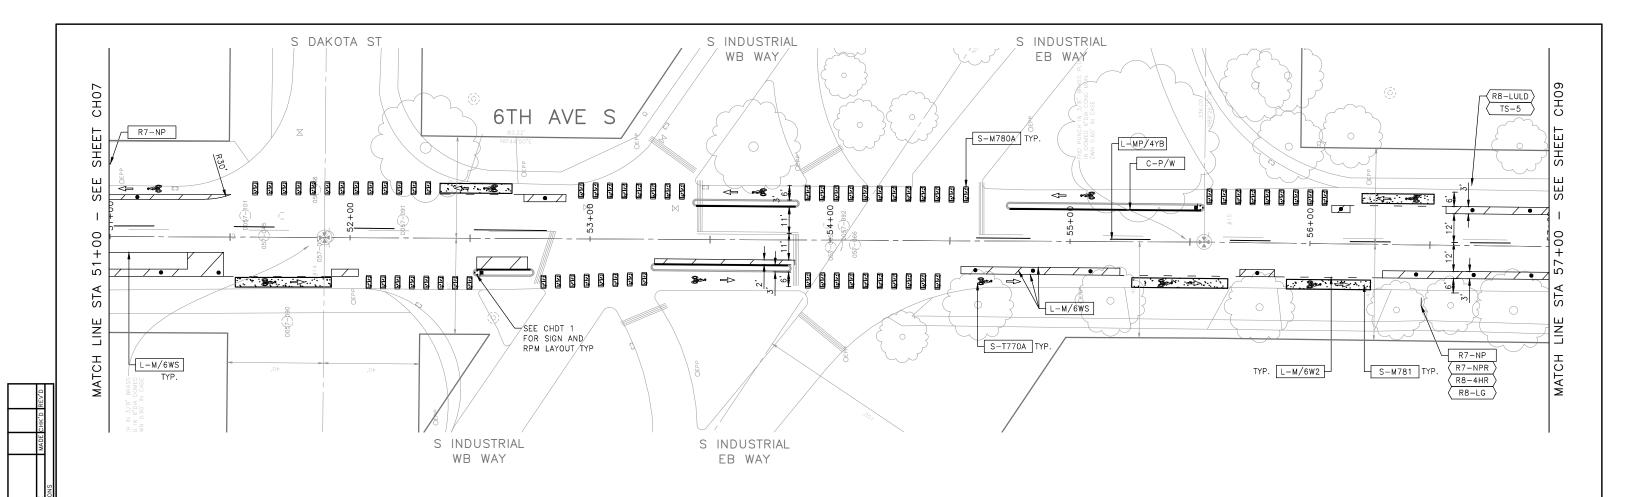

L-MP/4YD PROFILEDEMMA 4" SOLID DOUBLE YELLOW LINES W/4" SPACE BETWEEN L-MP/4YS PROFILED MMA 4" SOLID YELLOW LINE PROFILED MMA 4" SOLID YELLOW LINE W/ PARALLEL DASHED 4" L-MP/4YO YELLOW LINE, 10' PAINT AND 20' SKIP L-MP/4WB PROFILED MMA 4" DASHED WHITE LINE W/ 10' PAINT & 20' SKIP L-M/4W2 MMA 4" DASHED WHITE LINE W/2' PAINT & 4' SKIP L-M/6W2 MMA 6" DASHED WHITE LINE, W/2' PAINT & 4' SKIP L-M/6W3 MMA 6" DASHED WHITE LINE, W/3' PAINT & 6' SKIP L-M/6WS MMA 6" SOLID WHITE LINE L-MP/4WS PROFILED MMA 4" SOLID WHITE LINE L-T/SL16 THERMOPLASTIC 16" STOPLINE L-T/SL24 THERMOPLASTIC 24" STOPLINE L-M/8WS MMA 8" SOLID WHITE LINE L-T/XWK THERMOPLASTIC 8" CROSSWALK C-P/BUS BUS ZONE STRIPE, STD PLAN 713 C-P/Y YELLOW CURB STRIPE. STD PLAN 713

CHANNELIZATION LEGEND (CON'T)

S-T720A	THERMOPLASTIC LEFT ARROW
S-T720B	THERMOPLASTIC THROUGH ARROW
S-T720C	THERMOPLASTIC RIGHT ARROW
S-T721A	THERMOPLASTIC LEFT/THROUGH ARROW
S-T723A	THERMOPLASTIC LEFT MERGE ARROW
S-T730A	THERMOPLASTIC "ONLY" LEGEND
S-T730B	THERMOPLASTIC "BUS" LEGEND
S-T730C	THERMOPLASTIC "SLOW" LEGEND
S-T741A	THERMOPLASTIC PEDESTRIAN SYMBOL
S-T770A	THERMOPLASTIC BICYCLE LANE SYMBOL & ARROW
S-M770A	MMA BICYCLE LANE SYMBOL & ARROW
S-T771A	THERMOPLASTIC BIKE SHARROW
S-M771C	MMA BIKE SYMBOL
S-T773A	THERMOPLASTIC BIKE DOT.
S-M780A	MMA GREEN CROSS BIKE FOR ONE-WAY BIKE LANE
S-M781	MMA GREEN DRIVEWAY MARKING (SEE DETAIL ON CHDT1)
FDP28(36)W	FLEXIBLE DELINEATOR POST, 28"(36"), WHITE
GREEN	GREEN PAVEMENT MARKING (MMA)
	ONCERT FARENETT MANAGENE (MMA)

SIGNING LEGEND

SEE SHEET CHDT2 FOR SIGNING LEGEND AND SCHEDULE.

60% SUBMITTAL NOT FOR CONSTRUCTION JUNE 2023

	DEPARTMENT OF FINANCE & ADMINISTRATIVE SERVICES	INITIALS AND DATE DESIGNED CHECKED	INITIALS AND DATE REVIEWED: DES. CONST. SDOT PROJ. MGR.		Seattle Department of Transportation
PW#XXXX-XX		DRAWN	RECEIVED REVISED AS BUILT	51781 Matistreen	ORDINANCE NO. PW NO. XXXX-XX
	BY:PURCHASING AND CONTRACTING	ALL WORK SHALL BE DONE IN ACCORDANCE WITH T SPECIFICATIONS AND OTHER DOCUMENTS CALLED FO	THE CITY OF SEATTLE STANDARD PLANS AND R IN SECTION 0-02.3 OF THE PROJECT MANUAL.	SUDNAL S	SCALE: AS NOTED


NOTES


- 1. SEE SHEET NTO1 FOR ADDITIONAL NOTES.
- 2. INSTALL TYPE 2A MARKERS WITH LANE LINE MARKING PER SECT 8-22.1(2)C AND STD PLANS.
- 3. REMOVE EX MARKERS AND INSTALL YELLOW TYPE 2A LANE MARI ON MEDIAN AT 6' SPACING.
- 4. REMOVE ALL CONFLICTING EXISTING PAVEMENT MARKINGS AND LEGENDS UNLESS OTHERWISE NOTED

INSTALL

REMOVE

RELOCATE/MAINTAIN

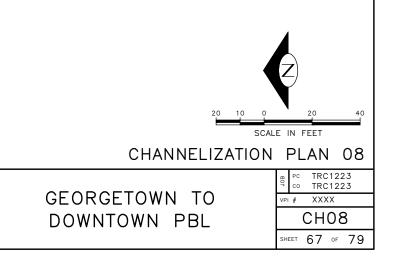

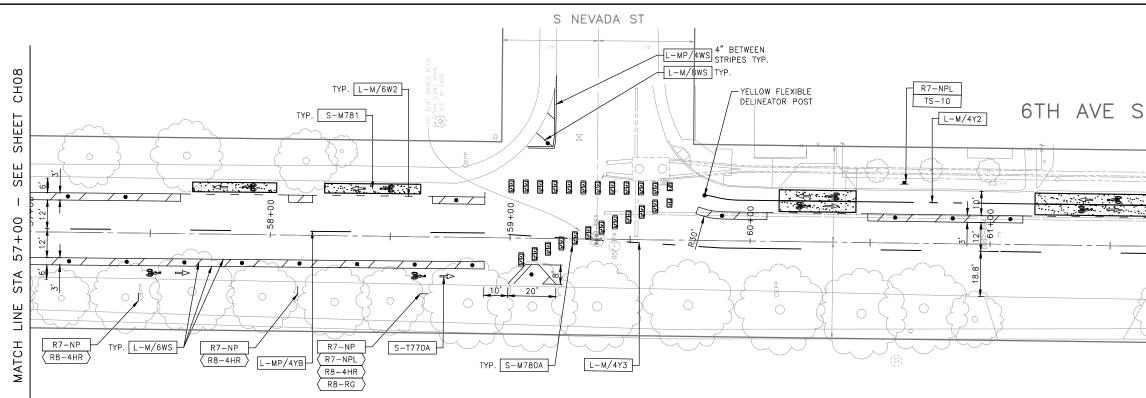

	CHANNELIZATION	LEGEND (<u>(CON'T)</u>
--	----------------	----------	----------------

L-MP/4YD	PROFILEDEMMA 4" SOLID DOUBLE YELLOW LINES W/4" SPACE BETWEEN
L-MP/4YS	PROFILED MMA 4" SOLID YELLOW LINE
L-MP/4YO	PROFILED MMA 4" SOLID YELLOW LINE W/ PARALLEL DASHED 4"
YELLOW LI	NE, 10' PAINT AND 20' SKIP
L-MP/4WB PROF	ILED MMA 4" DASHED WHITE LINE W/ 10' PAINT & 20' SKIP
L-M/4W2	MMA 4" DASHED WHITE LINE W/2' PAINT & 4' SKIP
L-M/6W2	MMA 6" DASHED WHITE LINE, W/2' PAINT & 4' SKIP
L-M/6W3	MMA 6" DASHED WHITE LINE, W/3' PAINT & 6' SKIP
L-M/6WS	MMA 6" SOLID WHITE LINE
L-MP/4WS PROF	ILED MMA 4" SOLID WHITE LINE
L-T/SL16	THERMOPLASTIC 16" STOPLINE
L-T/SL24	THERMOPLASTIC 24" STOPLINE
L-M/8WS	MMA 8" SOLID WHITE LINE
L-T/XWK	THERMOPLASTIC 8" CROSSWALK
C-P/BUS	BUS ZONE STRIPE, STD PLAN 713
C-P/Y	YELLOW CURB STRIPE, STD PLAN 713


S-T720A	THERMOPLASTIC LEFT ARROW
S-T720B	
S-T720C	THERMOPLASTIC RIGHT ARROW
S-T721A	THERMOPLASTIC LEFT/THROUGH ARROW
S-T723A	THERMOPLASTIC LEFT MERGE ARROW
S-T730A	THERMOPLASTIC "ONLY" LEGEND
S-T730B	THERMOPLASTIC "BUS" LEGEND
S-T730C	THERMOPLASTIC "SLOW" LEGEND
S-T741A	THERMOPLASTIC PEDESTRIAN SYMBOL
S-T770A	THERMOPLASTIC BICYCLE LANE SYMBOL & ARROW
S-M770A	MMA BICYCLE LANE SYMBOL & ARROW
S-T771A	THERMOPLASTIC BIKE SHARROW
S-M771C	MMA BIKE SYMBOL
S-T773A	THERMOPLASTIC BIKE DOT.
S-M780A	MMA GREEN CROSS BIKE FOR ONE-WAY BIKE LANE
S-M781	MMA GREEN DRIVEWAY MARKING (SEE DETAIL ON CHDT1)
FDP28(36)W	FLEXIBLE DELINEATOR POST, 28"(36"), WHITE
GREEN	GREEN PAVEMENT MARKING (MMA)


SIGNING LEGEND

SEE SHEET CHDT2 FOR SIGNING LEGEND AND SCHEDULE.

60% SUBMITTAL NOT FOR CONSTRUCTION JUNE 2023

	APPROVED FOR ADVERTISING DEPARTMENT OF FINANCE & ADMINISTRATIVE SERVICES SEATTLE, WASHINGTON	INITIALS AND DATE DESIGNED CHECKED	INITIALS AND DATE REVIEWED: DES. CONST. SDOT PROJ. MGR.		Seattle Department of Transportation
PW#XXXX-XX		DRAWN CHECKED	RECEIVED REVISED AS BUILT	51781 Precistere	
	BY:	ALL WORK SHALL BE DONE IN ACCORDANCE WITH T SPECIFICATIONS AND OTHER DOCUMENTS CALLED FO		STONAL EN	SCALE: AS NOTED

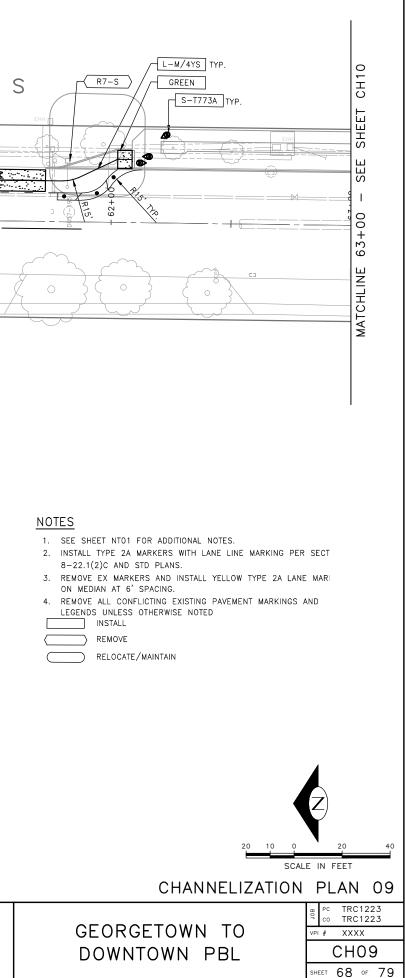

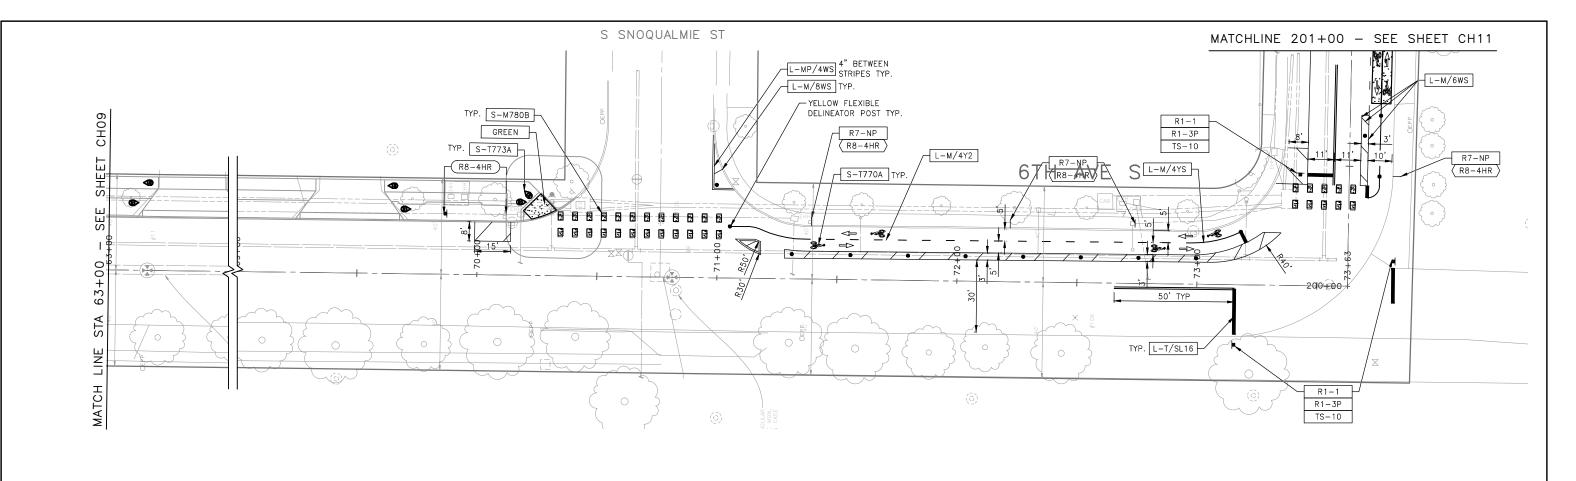

CHANNELIZATION LEGE	END (CON'T)
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L-MP/4YD	PROFILEDEMMA 4" SOLID DOUBLE YELLOW LINES W/4" SPACE BETWEEN
L-MP/4YS	PROFILED MMA 4" SOLID YELLOW LINE
	PROFILED MMA 4" SOLID YELLOW LINE W/ PARALLEL DASHED 4" NE, 10' PAINT AND 20' SKIP
L-MP/4WB PROF	ILED MMA 4" DASHED WHITE LINE W/ 10' PAINT & 20' SKIP
L-M/4W2	MMA 4" DASHED WHITE LINE W/2' PAINT & 4' SKIP
L-M/6W2	MMA 6" DASHED WHITE LINE, W/2' PAINT & 4' SKIP
L-M/6W3	MMA 6" DASHED WHITE LINE, W/3' PAINT & 6' SKIP
L-M/6WS	MMA 6" SOLID WHITE LINE
L-MP/4WS PROF	ILED MMA 4" SOLID WHITE LINE
L-T/SL16	THERMOPLASTIC 16" STOPLINE
L-T/SL24	THERMOPLASTIC 24" STOPLINE
L-M/8WS	MMA 8" SOLID WHITE LINE
L-T/XWK	THERMOPLASTIC 8" CROSSWALK
C-P/BUS	BUS ZONE STRIPE, STD PLAN 713
C-P/Y	YELLOW CURB STRIPE. STD PLAN 713

S-T770A THERMOPLASTIC BICYCLE LANE SYMBOL & ARROW S-M770A MMA BICYCLE LANE SYMBOL & ARROW S-T771A THERMOPLASTIC BIKE SHARROW S-M771C MMA BIKE SYMBOL S-T773A THERMOPLASTIC BIKE DOT. S-M780A MMA GREEN CROSS BIKE FOR ONE-WAY BIKE LANE	S-T720A S-T720B S-T720C S-T721A S-T723A S-T730A S-T730B S-T730C S-T741A	THERMOPLASTIC LEFT ARROW THERMOPLASTIC THROUGH ARROW THERMOPLASTIC RIGHT ARROW THERMOPLASTIC LEFT/THROUGH ARROW THERMOPLASTIC 'EFT MERGE ARROW THERMOPLASTIC "BUS" LEGEND THERMOPLASTIC "SLOW" LEGEND THERMOPLASTIC PEDESTRIAN SYMBOL
S-M781 MMA GREEN DRIVEWAY MARKING (SEE DETAIL ON CHDT1) FDP28(36)W FLEXIBLE DELINEATOR POST, 28"(36"), WHITE GREEN FINITIAL GREEN PAVEMENT MARKING (MMA)	S-T730B S-T730C S-T741A S-T770A S-T771A S-T771A S-M771C S-T773A S-M780A S-M781 FDP28(36)W	THERMOPLASTIC "BUS" LEGEND THERMOPLASTIC "SLOW" LEGEND THERMOPLASTIC PEDESTRIAN SYMBOL THERMOPLASTIC BICYCLE LANE SYMBOL & ARROW MMA BICYCLE LANE SYMBOL & ARROW THERMOPLASTIC BIKE SHARROW MMA BIKE SYMBOL THERMOPLASTIC BIKE DOT. MMA GREEN CROSS BIKE FOR ONE-WAY BIKE LANE MMA GREEN DRIVEWAY MARKING (SEE DETAIL ON CHDT1) FLEXIBLE DELINEATOR POST, 28"(36"), WHITE

SIGNING LEGEND

SEE SHEET CHDT2 FOR SIGNING LEGEND AND SCHEDULE.


60% SUBMITTAL NOT FOR CONSTRUCTION JUNE 2023


	APPROVED FOR ADVERTISING	INITIALS AND DATE	INITIALS AND DATE	REAL	ANN Seattle
	DEPARTMENT OF FINANCE & ADMINISTRATIVE SERVICES	DESIGNED CHECKED	REVIEWED: DES. CONST. SDOT PROJ. MGR.		Department of Transportation
PW#XXXX-XX	SEATTLE, WASHINGTON	DRAWN CHECKED	RECEIVED REVISED AS BUILT	517B1	ORDINANCE NO. PW NO. XXXX-XX
	BY:	ALL WORK SHALL BE DONE IN ACCORDANCE WITH SPECIFICATIONS AND OTHER DOCUMENTS CALLED F	THE CITY OF SEATTLE STANDARD PLANS AND FOR IN SECTION 0-02.3 OF THE PROJECT MANUAL.	NAL NAL	SCALE: AS NOTED

NOTES

- 1. SEE SHEET NT01 FOR ADDITIONAL NOTES.
- 2. INSTALL TYPE 2A MARKERS WITH LANE LINE MARKING PER SECT 8-22.1(2)C AND STD PLANS.
- 3. REMOVE EX MARKERS AND INSTALL YELLOW TYPE 2A LANE MARI ON MEDIAN AT 6' SPACING.
- 4. REMOVE ALL CONFLICTING EXISTING PAVEMENT MARKINGS AND LEGENDS UNLESS OTHERWISE NOTED
- INSTALL
- REMOVE

RELOCATE/MAINTAIN

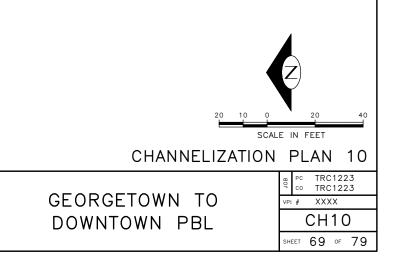

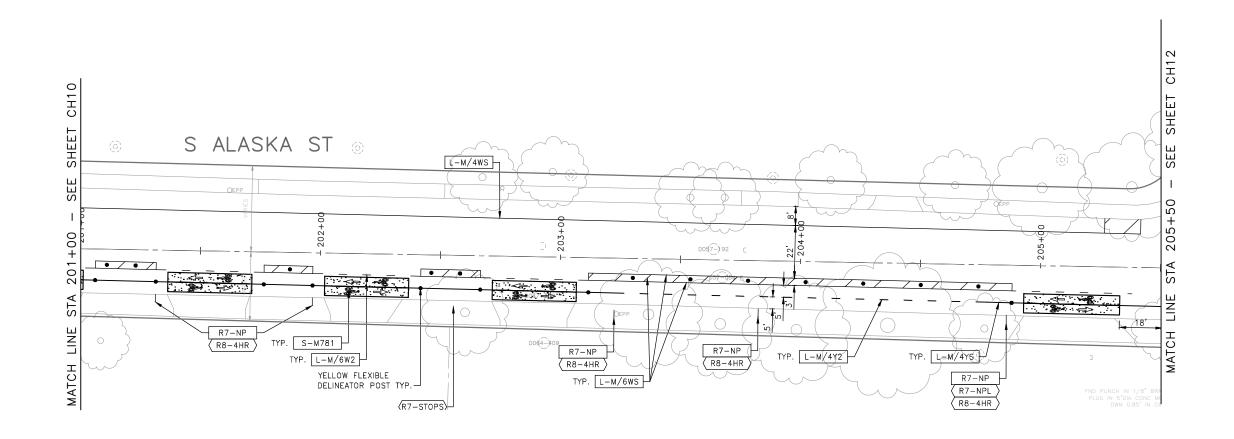

CHANNELIZATION LEGEND (CON'T)

,	PROFILEDEMMA 4" SOLID DOUBLE YELLOW LINES W/4" SPACE BETWEEN
L-MP/4YS	PROFILED MMA 4" SOLID YELLOW LINE
L-MP/4YO	PROFILED MMA 4" SOLID YELLOW LINE W/ PARALLEL DASHED 4"
YELLOW	LINE, 10' PAINT AND 20' SKIP
L-MP/4WB PR	OFILED MMA 4" DASHED WHITE LINE W/ 10' PAINT & 20' SKIP
L-M/4W2	MMA 4" DASHED WHITE LINE W/2' PAINT & 4' SKIP
L-M/6W2	MMA 6" DASHED WHITE LINE, W/2' PAINT & 4' SKIP
L-M/6W3	MMA 6" DASHED WHITE LINE, W/3' PAINT & 6' SKIP
L-M/6WS	MMA 6" SOLID WHITE LINE
L-MP/4WS PR	OFILED MMA 4" SOLID WHITE LINE
L-T/SL16	THERMOPLASTIC 16" STOPLINE
L-T/SL24	THERMOPLASTIC 24" STOPLINE
L-M/8WS	MMA 8" SOLID WHITE LINE
L-T/XWK	THERMOPLASTIC 8" CROSSWALK
C-P/BUS	BUS ZONE STRIPE, STD PLAN 713
C-P/Y	YELLOW CURB STRIPE. STD PLAN 713

S-T720A	THERMOPLASTIC LEFT ARROW
S-T720B	THERMOPLASTIC THROUGH ARROW
S-T720C	THERMOPLASTIC RIGHT ARROW
S-T721A	THERMOPLASTIC LEFT/THROUGH ARROW
S-T723A	THERMOPLASTIC LEFT MERGE ARROW
S-T730A	THERMOPLASTIC "ONLY" LEGEND
S-T730B	THERMOPLASTIC "BUS" LEGEND
S-T730C	THERMOPLASTIC "SLOW" LEGEND
S-T741A	THERMOPLASTIC PEDESTRIAN SYMBOL
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S-T771A	THERMOPLASTIC BIKE SHARROW
S-M771C	MMA BIKE SYMBOL
S-T773A	THERMOPLASTIC BIKE DOT.
S-M780A	MMA GREEN CROSS BIKE FOR ONE-WAY BIKE LANE
S-M781	MMA GREEN DRIVEWAY MARKING (SEE DETAIL ON CHDT1)
FDP28(36)W	FLEXIBLE DELINEATOR POST, 28"(36"), WHITE
GREEN	GREEN PAVEMENT MARKING (MMA)

SIGNING LEGEND

SEE SHEET CHDT2 FOR SIGNING LEGEND AND SCHEDULE.


60% SUBMITTAL NOT FOR CONSTRUCTION JUNE 2023


	APPROVED FOR ADVERTISING	INITIALS AND DATE	INITIALS AND DATE	SER TRA	KUIN Seattle
	DEPARTMENT OF FINANCE & ADMINISTRATIVE SERVICES SEATTLE, WASHINGTON	DESIGNED CHECKED	REVIEWED: DES. CONST. SDOT PROJ. MGR.		Seattle Department of Transportation
PW#XXXX-XX		DRAWN CHECKED	RECEIVED REVISED AS BUILT	51781	
	BY:PURCHASING AND CONTRACTING	ALL WORK SHALL BE DONE IN ACCORDANCE WITH SPECIFICATIONS AND OTHER DOCUMENTS CALLED FO		SCALE: AS NO	SCALE: AS NOTED

NOTES

- 1. SEE SHEET NTO1 FOR ADDITIONAL NOTES.
- INSTALL TYPE 2A MARKERS WITH LANE LINE MARKING PER SECT 8-22.1(2)C AND STD PLANS.
- REMOVE EX MARKERS AND INSTALL YELLOW TYPE 2A LANE MARI ON MEDIAN AT 6' SPACING.
- 4. REMOVE ALL CONFLICTING EXISTING PAVEMENT MARKINGS AND LEGENDS UNLESS OTHERWISE NOTED
- - REMOVE

RELOCATE/MAINTAIN

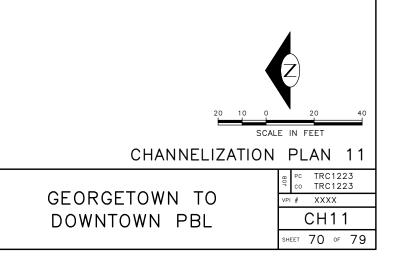


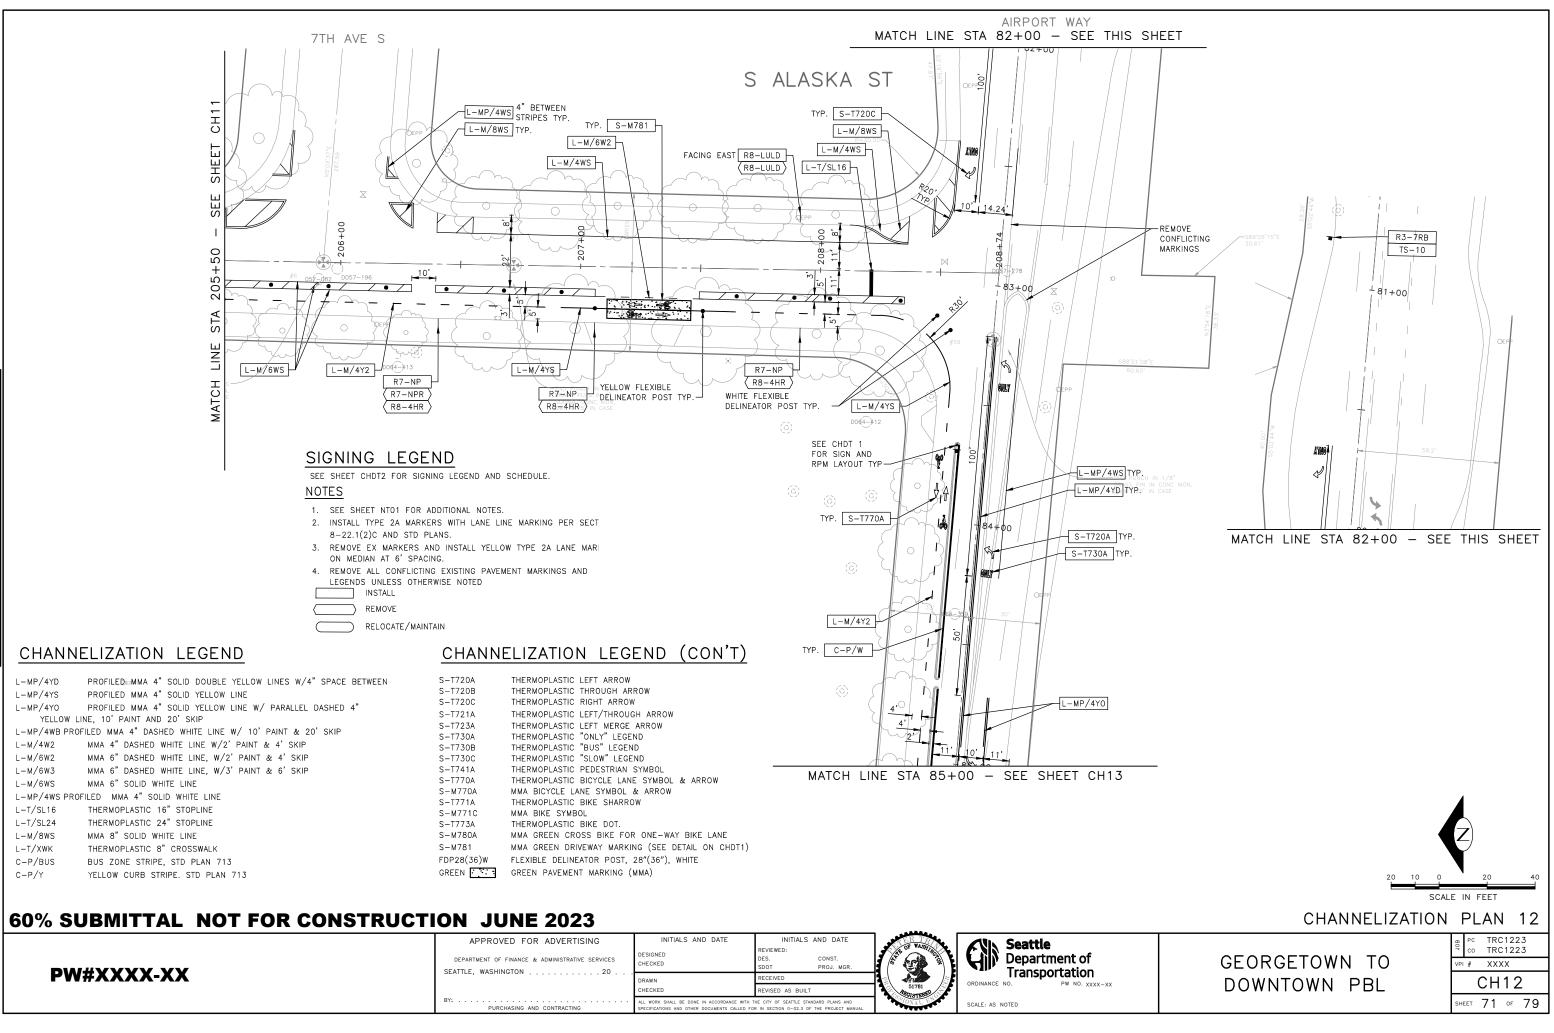

GEORG

TRC1223-JUNE 01

	APPROVED FOR ADVERTISING DEPARTMENT OF FINANCE & ADMINISTRATIVE SERVICES SEATTLE, WASHINGTON	INITIALS AND DATE DESIGNED CHECKED	INITIALS AND DATE REVIEWED: DES. CONST. SDOT PROJ. MGR.		Seattle Department of
PW#XXXX-XX		DRAWN CHECKED	RECEIVED REVISED AS BUILT	51781 STREET	ORDINANCE NO. PW NO. XXXX-XX
	BY:	ALL WORK SHALL BE DONE IN ACCORDANCE WITH SPECIFICATIONS AND OTHER DOCUMENTS CALLED FO		SIONAL SS	SCALE: AS NOTED

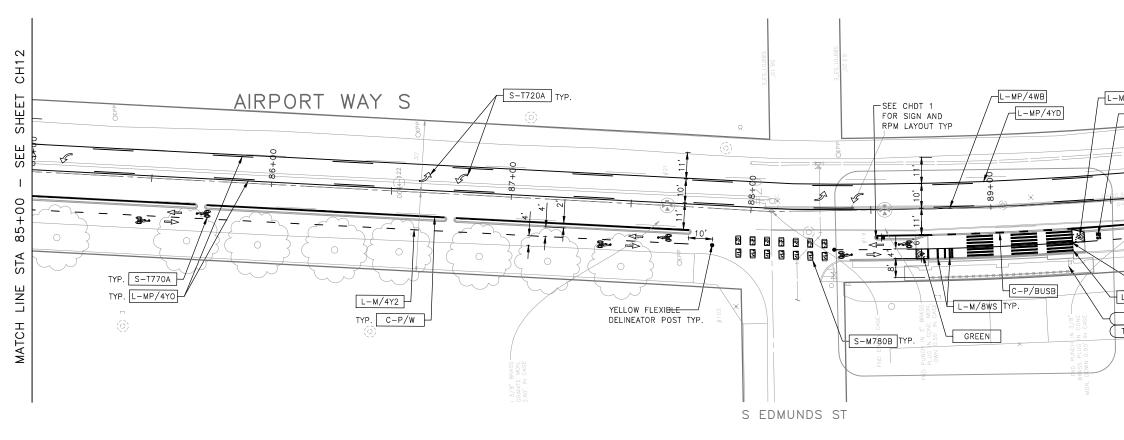

--GEORGETOWN TO 2023 12:15PM

TRC1223-

CHANNELIZATION LEGEND (CON'T)

THERMOPLASTIC LEFT ARROW

THERMOPLASTIC THROUGH ARROW

L-MP/4YD	$\label{eq:profiled_embedded} PROFILED_{embedded} MMA \ 4" \ SOLID \ DOUBLE \ YELLOW \ LINES \ W/4" \ SPACE \ BETWEEN$
L-MP/4YS	PROFILED MMA 4" SOLID YELLOW LINE
L-MP/4YO	PROFILED MMA 4" SOLID YELLOW LINE W/ PARALLEL DASHED 4"
YELLOW LIN	NE, 10' PAINT AND 20' SKIP
L-MP/4WB PROF	ILED MMA 4" DASHED WHITE LINE W/ 10' PAINT & 20' SKIP
L-M/4W2	MMA 4" DASHED WHITE LINE W/2' PAINT & 4' SKIP
L-M/6W2	MMA 6" DASHED WHITE LINE, W/2' PAINT & 4' SKIP
L−M/6W3	MMA 6" DASHED WHITE LINE, W/3' PAINT & 6' SKIP
L-M/6WS	MMA 6" SOLID WHITE LINE
L-MP/4WS PROF	ILED MMA 4" SOLID WHITE LINE
L-T/SL16	THERMOPLASTIC 16" STOPLINE
L-T/SL24	THERMOPLASTIC 24" STOPLINE
L-M/8WS	MMA 8" SOLID WHITE LINE
L-T/XWK	THERMOPLASTIC 8" CROSSWALK
C-P/BUS	BUS ZONE STRIPE, STD PLAN 713
C-P/Y	YELLOW CURB STRIPE. STD PLAN 713

S-T720C THERMOPLASTIC RIGHT ARROW THERMOPLASTIC LEFT/THROUGH ARROW S-T721A THERMOPLASTIC LEFT MERGE ARROW S-T723A S-T730A THERMOPLASTIC "ONLY" LEGEND S-T730B THERMOPLASTIC "BUS" LEGEND S-T730C THERMOPLASTIC "SLOW" LEGEND S-T741A THERMOPLASTIC PEDESTRIAN SYMBOL S-T770A THERMOPLASTIC BICYCLE LANE SYMBOL & ARROW S-M770A MMA BICYCLE LANE SYMBOL & ARROW S-T771A THERMOPLASTIC BIKE SHARROW S-M771C MMA BIKE SYMBOL S-T773A THERMOPLASTIC BIKE DOT. S-M780A MMA GREEN CROSS BIKE FOR ONE-WAY BIKE LANE S-M781 MMA GREEN DRIVEWAY MARKING (SEE DETAIL ON CHDT1) FDP28(36)W FLEXIBLE DELINEATOR POST, 28"(36"), WHITE GREEN GREEN PAVEMENT MARKING (MMA)

SIGNING LEGEND


SEE SHEET CHDT2 FOR SIGNING LEGEND AND SCHEDULE.


60% SUBMITTAL NOT FOR CONSTRUCTION JUNE 2023

PW#XXXX-XX	APPROVED FOR ADVERTISING DEPARTMENT OF FINANCE & ADMINISTRATIVE SERVICES SEATTLE, WASHINGTON	DESIGNED CHECKED DRAWN	INITIALS AND DATE REVIEWED: DES. CONST. SDOT PROJ. MGR. RECEIVED REVISED AS BUILT	ST781	Seattle Department of Transportation
	BY:	ALL WORK SHALL BE DONE IN ACCORDANCE WITH T		A A A A A A A A A A A A A A A A A A A	SCALE: AS NOTED

S-T720A

S-T720B

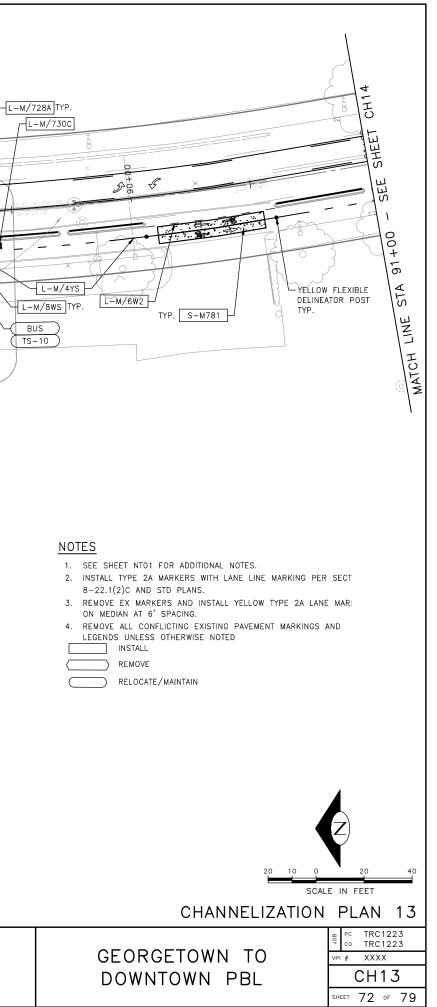

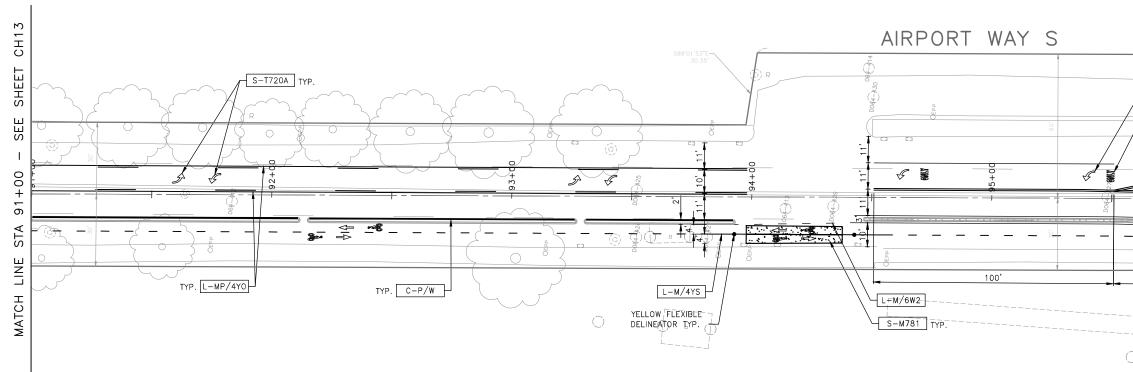

CHANNELIZATION LEGEND (CON'T)


L-MP/4YD	PROFILEDEMMA 4" SOLID DOUBLE YELLOW LINES W/4" SPACE BETWEEN
L-MP/4YS	PROFILED MMA 4" SOLID YELLOW LINE
L-MP/4YO	PROFILED MMA 4" SOLID YELLOW LINE W/ PARALLEL DASHED 4"
YELLOW LI	NE, 10' PAINT AND 20' SKIP
L-MP/4WB PROF	ILED MMA 4" DASHED WHITE LINE W/ 10' PAINT & 20' SKIP
L-M/4W2	MMA 4" DASHED WHITE LINE W/2' PAINT & 4' SKIP
L-M/6W2	MMA 6" DASHED WHITE LINE, W/2' PAINT & 4' SKIP
L-M/6W3	MMA 6" DASHED WHITE LINE, W/3' PAINT & 6' SKIP
L-M/6WS	MMA 6" SOLID WHITE LINE
L-MP/4WS PROF	ILED MMA 4" SOLID WHITE LINE
L-T/SL16	THERMOPLASTIC 16" STOPLINE
L-T/SL24	THERMOPLASTIC 24" STOPLINE
L-M/8WS	MMA 8" SOLID WHITE LINE
L-T/XWK	THERMOPLASTIC 8" CROSSWALK
C-P/BUS	BUS ZONE STRIPE, STD PLAN 713
C-P/Y	YELLOW CURB STRIPE. STD PLAN 713


S-T720A	THERMOPLASTIC LEFT ARROW
S-T720B	THERMOPLASTIC THROUGH ARROW
S-T720C	THERMOPLASTIC RIGHT ARROW
S-T721A	THERMOPLASTIC LEFT/THROUGH ARROW
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S-T730A	THERMOPLASTIC "ONLY" LEGEND
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S-T730C	THERMOPLASTIC "SLOW" LEGEND
S-T741A	THERMOPLASTIC PEDESTRIAN SYMBOL
S-T770A	THERMOPLASTIC BICYCLE LANE SYMBOL & ARROW
S-M770A	MMA BICYCLE LANE SYMBOL & ARROW
S-T771A	THERMOPLASTIC BIKE SHARROW
S-M771C	MMA BIKE SYMBOL
S-T773A	THERMOPLASTIC BIKE DOT.
S-M780A	MMA GREEN CROSS BIKE FOR ONE-WAY BIKE LANE
S-M781	MMA GREEN DRIVEWAY MARKING (SEE DETAIL ON CHDT1)
FDP28(36)W	FLEXIBLE DELINEATOR POST, 28"(36"), WHITE
GREEN	GREEN PAVEMENT MARKING (MMA)
	(

SIGNING LEGEND

SEE SHEET CHDT2 FOR SIGNING LEGEND AND SCHEDULE.

	DEPARTMENT OF FINANCE & ADMINISTRATIVE SERVICES SEATTLE, WASHINGTON	INITIALS AND DATE DESIGNED CHECKED	INITIALS AND DATE REVIEWED: DES. CONST. SDOT PROJ. MGR.		OF WAR	"IN	y y y	Seattle Department of Transportation
PW#XXXX-XX		DRAWN CHECKED	RECEIVED REVISED AS BUILT THE CITY OF SEATTLE STANDARD PLANS AND		51781 REGISTER	60	F	ORDINANCE NO. PW NO. XXXX-XX
	PURCHASING AND CONTRACTING	SPECIFICATIONS AND OTHER DOCUMENTS CALLED FO		1 7	TONAL			SCALE: AS NOTED

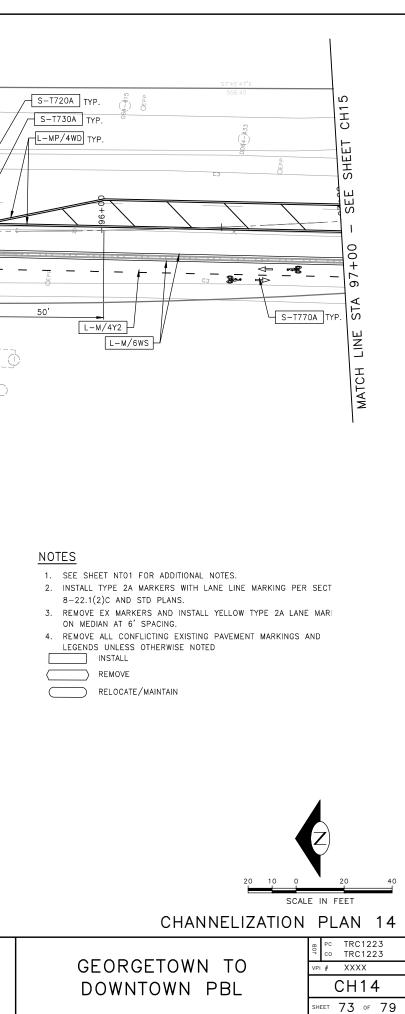

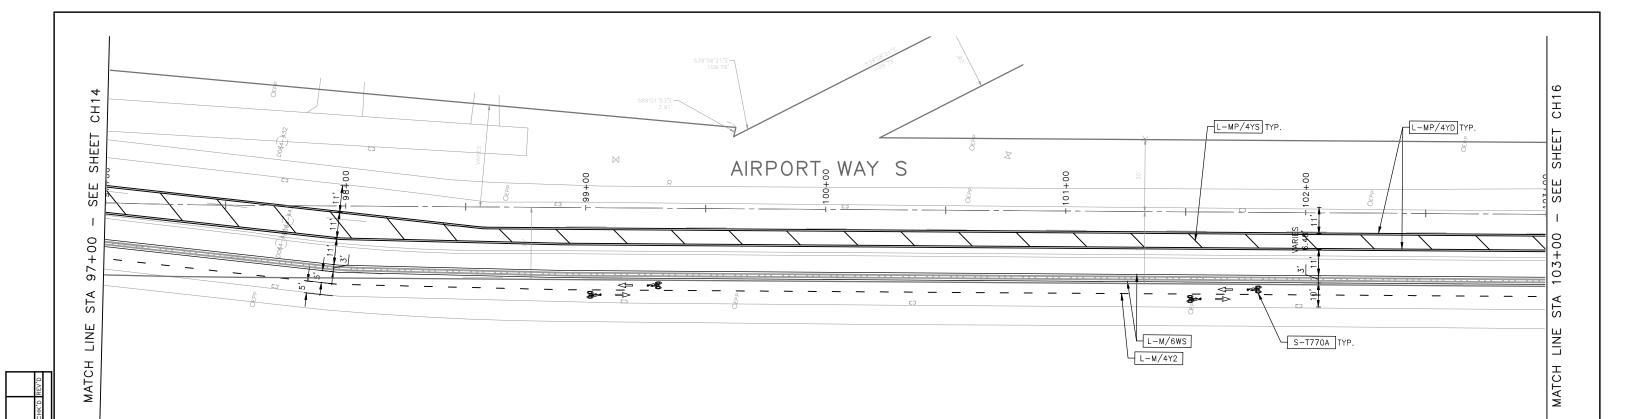

CHANNELIZATION LEGEND (CON'T)

L-MP/4YD	PROFILEDEMMA 4" SOLID DOUBLE YELLOW LINES W/4" SPACE BETWEEN
L-MP/4YS	PROFILED MMA 4" SOLID YELLOW LINE
L-MP/4YO	PROFILED MMA 4" SOLID YELLOW LINE W/ PARALLEL DASHED 4"
YELLOW LI	NE, 10' PAINT AND 20' SKIP
L-MP/4WB PROF	ILED MMA 4" DASHED WHITE LINE W/ 10' PAINT & 20' SKIP
L-M/4W2	MMA 4" DASHED WHITE LINE W/2' PAINT & 4' SKIP
L-M/6W2	MMA 6" DASHED WHITE LINE, W/2' PAINT & 4' SKIP
L-M/6W3	MMA 6" DASHED WHITE LINE, W/3' PAINT & 6' SKIP
L-M/6WS	MMA 6" SOLID WHITE LINE
L-MP/4WS PROF	ILED MMA 4" SOLID WHITE LINE
L-T/SL16	THERMOPLASTIC 16" STOPLINE
L-T/SL24	THERMOPLASTIC 24" STOPLINE
L-M/8WS	MMA 8" SOLID WHITE LINE
L-T/XWK	THERMOPLASTIC 8" CROSSWALK
C-P/BUS	BUS ZONE STRIPE, STD PLAN 713
C-P/Y	YELLOW CURB STRIPE. STD PLAN 713

S-T720A	THERMOPLASTIC LEFT ARROW
S-T720B	THERMOPLASTIC THROUGH ARROW
S-T720C	THERMOPLASTIC RIGHT ARROW
S-T721A	THERMOPLASTIC LEFT/THROUGH ARROW
S-T723A	THERMOPLASTIC LEFT MERGE ARROW
S-T730A	THERMOPLASTIC "ONLY" LEGEND
S-T730B	THERMOPLASTIC "BUS" LEGEND
S-T730C	THERMOPLASTIC "SLOW" LEGEND
S-1741A	THERMOPLASTIC PEDESTRIAN SYMBOL
S-T770A	THERMOPLASTIC BICYCLE LANE SYMBOL & ARROW
S-M770A	MMA BICYCLE LANE SYMBOL & ARROW
S-⊤771A	THERMOPLASTIC BIKE SHARROW
S-M771C	MMA BIKE SYMBOL
S-1773A	THERMOPLASTIC BIKE DOT.
S-M780A	MMA GREEN CROSS BIKE FOR ONE-WAY BIKE LANE
S-M781	MMA GREEN DRIVEWAY MARKING (SEE DETAIL ON CHDT1)
FDP28(36)W	FLEXIBLE DELINEATOR POST, 28"(36"), WHITE
GREEN	GREEN PAVEMENT MARKING (MMA)
	OKEEN FAVEMENT MAKKING (MMA)

SIGNING LEGEND

SEE SHEET CHDT2 FOR SIGNING LEGEND AND SCHEDULE.


60% SUBMITTAL NOT FOR CONSTRUCTION JUNE 2023


				. مقاقد	
	APPROVED FOR ADVERTISING	INITIALS AND DATE	INITIALS AND DATE	S SER TRANS	KNIN Seattle
PW#XXXX-XX	DEPARTMENT OF FINANCE & ADMINISTRATIVE SERVICES	DESIGNED CHECKED	REVIEWED: DES. CONST. SDOT PROJ. MGR.		Department of
	SEATTLE, WASHINGTON	DRAWN	RECEIVED	51781	ORDINANCE NO. PW NO. XXXX-XX
			REVISED AS BUILT	RECISTERED	
	PURCHASING AND CONTRACTING	ALL WORK SHALL BE DONE IN ACCORDANCE WITH SPECIFICATIONS AND OTHER DOCUMENTS CALLED FO		STONAL VY	SCALE: AS NOTED

NOTES

- 1. SEE SHEET NTO1 FOR ADDITIONAL NOTES.
- 2. INSTALL TYPE 2A MARKERS WITH LANE LINE MARKING PER SECT 8-22.1(2)C AND STD PLANS.
- 3. REMOVE EX MARKERS AND INSTALL YELLOW TYPE 2A LANE MARI ON MEDIAN AT 6' SPACING.
- 4. REMOVE ALL CONFLICTING EXISTING PAVEMENT MARKINGS AND LEGENDS UNLESS OTHERWISE NOTED
- INSTALL
- REMOVE

RELOCATE/MAINTAIN

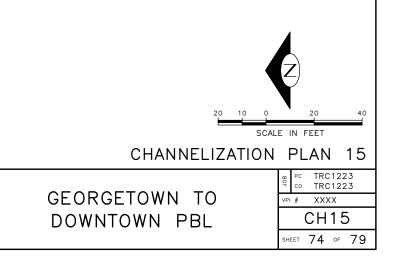

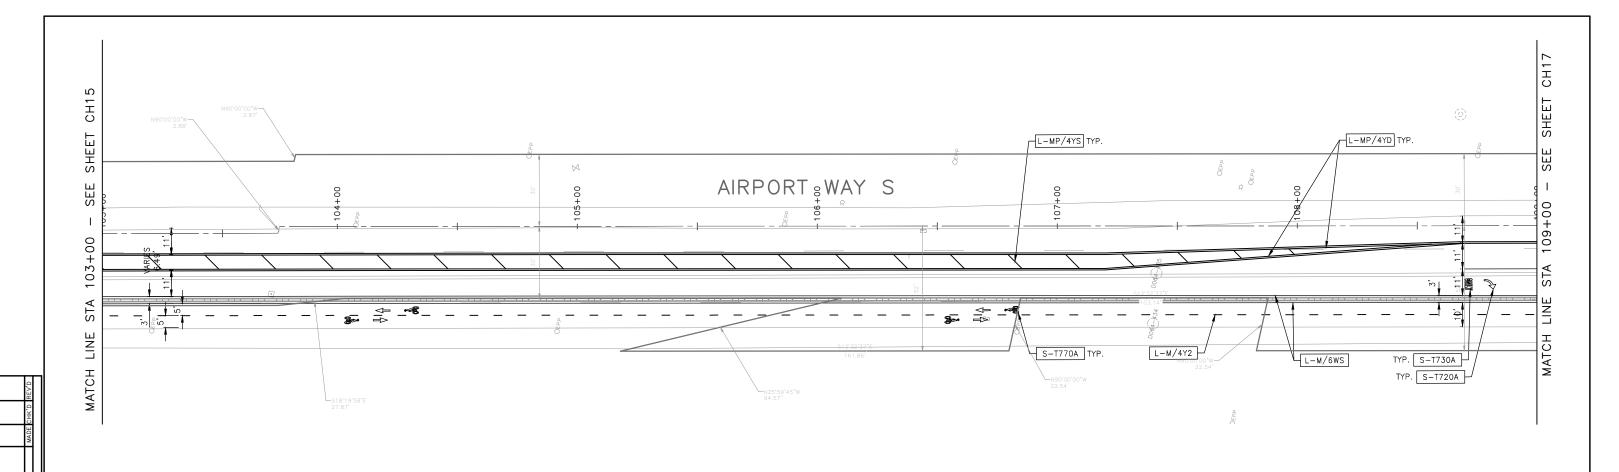

CHANNELIZATION LEGEND (CON'T)

L-MP/4YD	PROFILEDEMMA 4" SOLID DOUBLE YELLOW LINES W/4" SPACE BETWEEN
L-MP/4YS	PROFILED MMA 4" SOLID YELLOW LINE
L-MP/4YO	PROFILED MMA 4" SOLID YELLOW LINE W/ PARALLEL DASHED 4"
YELLOW LI	NE, 10' PAINT AND 20' SKIP
L-MP/4WB PROF	ILED MMA 4" DASHED WHITE LINE W/ 10' PAINT & 20' SKIP
L-M/4W2	MMA 4" DASHED WHITE LINE W/2' PAINT & 4' SKIP
L-M/6W2	MMA 6" DASHED WHITE LINE, W/2' PAINT & 4' SKIP
L-M/6W3	MMA 6" DASHED WHITE LINE, W/3' PAINT & 6' SKIP
L-M/6WS	MMA 6" SOLID WHITE LINE
L-MP/4WS PROF	ILED MMA 4" SOLID WHITE LINE
L-T/SL16	THERMOPLASTIC 16" STOPLINE
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L-T/XWK	THERMOPLASTIC 8" CROSSWALK
C-P/BUS	BUS ZONE STRIPE, STD PLAN 713
C-P/Y	YELLOW CURB STRIPE. STD PLAN 713

S-T720A	THERMOPLASTIC LEFT ARROW
S-T720B	THERMOPLASTIC THROUGH ARROW
S-T720C	THERMOPLASTIC RIGHT ARROW
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FDP28(36)W	FLEXIBLE DELINEATOR POST, 28"(36"), WHITE
GREEN	GREEN PAVEMENT MARKING (MMA)
	(

SIGNING LEGEND


SEE SHEET CHDT2 FOR SIGNING LEGEND AND SCHEDULE.


#XXXX-XX	DEPARTMENT OF FINANCE & ADMINISTRATIVE SERVICES SEATTLE, WASHINGTON	INITIALS AND DATE DESIGNED CHECKED	INITIALS AND DATE REVIEWED: DES. CONST. SDOT PROJ. MGR.	A COLORED TO A COL	Seattle Department of
		DRAWN CHECKED	RECEIVED REVISED AS BUILT	51781	ORDINANCE NO. PW NO. XXXX-XX
	BY:	ALL WORK SHALL BE DONE IN ACCORDANCE WITH T SPECIFICATIONS AND OTHER DOCUMENTS CALLED FO	THE CITY OF SEATTLE STANDARD PLANS AND R IN SECTION 0-02.3 OF THE PROJECT MANUAL.	NAL NAL	SCALE: AS NOTED

NOTES

- 1. SEE SHEET NT01 FOR ADDITIONAL NOTES.
- 2. INSTALL TYPE 2A MARKERS WITH LANE LINE MARKING PER SECT $8\!-\!22.1(2)C$ and STD plans.
- REMOVE EX MARKERS AND INSTALL YELLOW TYPE 2A LANE MARI ON MEDIAN AT 6' SPACING.
- 4. REMOVE ALL CONFLICTING EXISTING PAVEMENT MARKINGS AND LEGENDS UNLESS OTHERWISE NOTED
- INSTALL
- REMOVE

RELOCATE/MAINTAIN

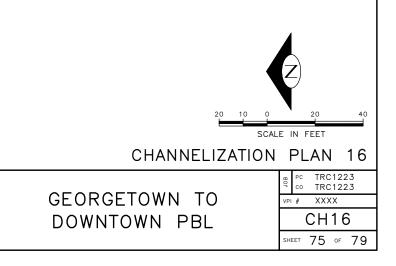

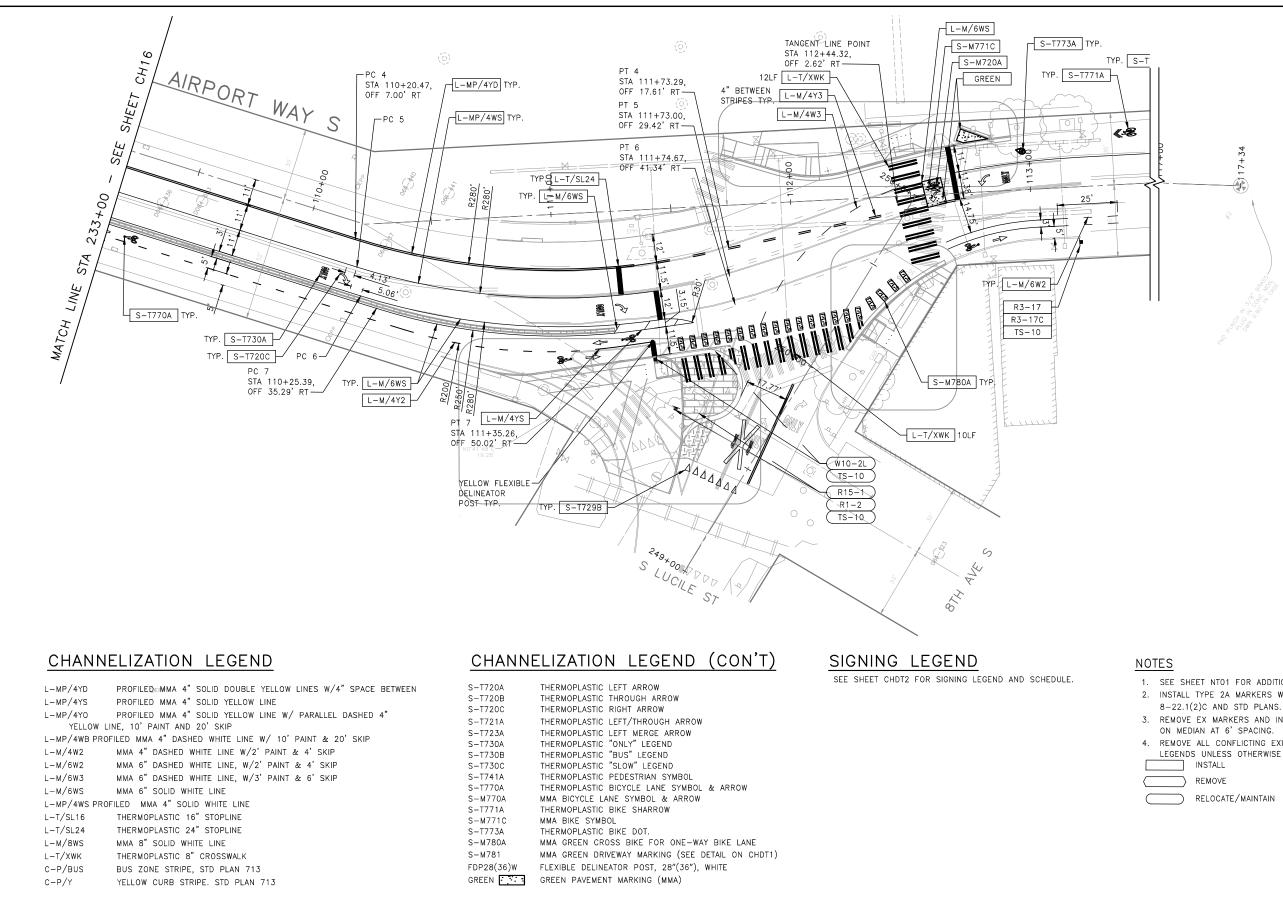

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ETOWN TO 12:19PM

-GEOR(2023

TRC1223-JUNE 01

- 1. SEE SHEET NTO1 FOR ADDITIONAL NOTES.
- 2. INSTALL TYPE 2A MARKERS WITH LANE LINE MARKING PER SECT
- 3. REMOVE EX MARKERS AND INSTALL YELLOW TYPE 2A LANE MAR
- REMOVE ALL CONFLICTING EXISTING PAVEMENT MARKINGS AND LEGENDS UNLESS OTHERWISE NOTED



SCALE IN FEET

TRC1223 TRC1223


CH17

SHEET 76 OF 79

VPI # XXXX

CHANNELIZATION PLAN 17



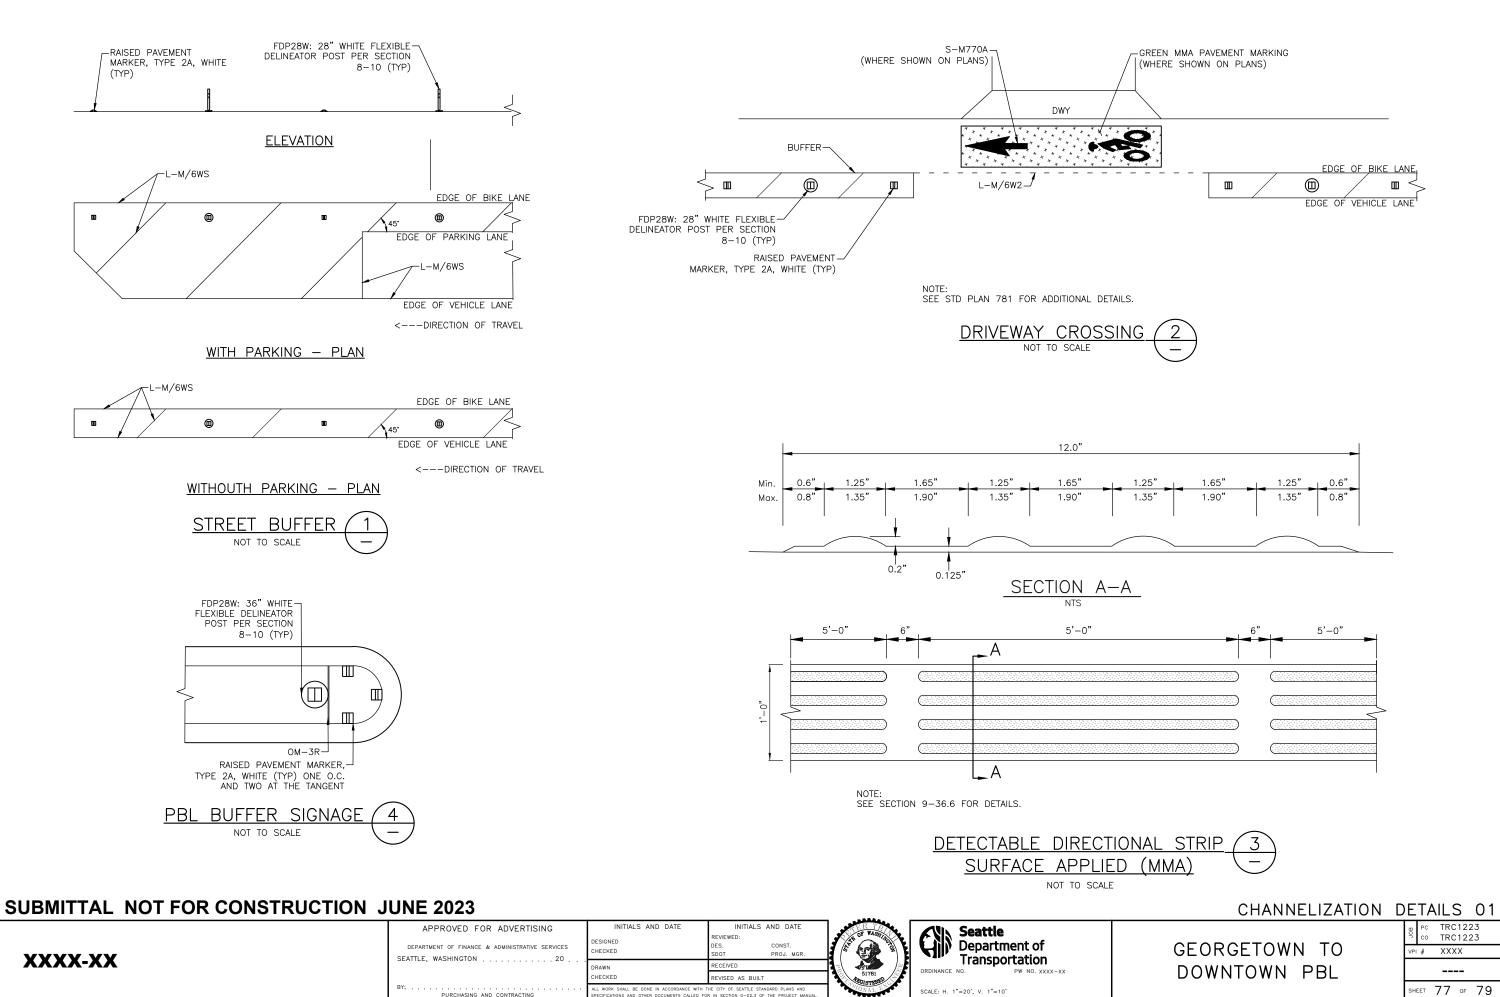

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SCALE: H. 1"=20', V. 1"=10'

SIGN SCHEDULE (CONT.)							
SIGN CODE	SIGN TEXT/ DESCREPTION	SIGN IMAGE	SIGN SIZE				
R8-4HR	4H PARKING 7A–6P EXC SUN–HOL	HOUR 7AM-6PM ESCEPT SEMMOL	12X18 RECTANGLE GREEN/WHIT				
R8–LBY	[LEFT ARROW]	ł	12X6 RECTANGLE BLACK/YELW				
R8-LULD	30M LOAD & UNLOAD ONLY 7A-6P EXC SUN-HOL, TAZ	30 MINUTE LOAD AND UNLOAD ONLY 7AN-6 EN MORE DO ST	12X18 RECTANGLE BLACK/YELW RED/WHIT				
R8-LG	[LEFT ARROW]	ł	12X6 RECTANGLE GREEN/WHIT				
R8-RG	[RIGHT ARROW]		12X6 RECTANGLE GREEN/WHIT				
W10-1	[R LARGE X R]		36X36 CIRCLE BLACK/YELW	[(
W10-131	[BIKE],[RAILROAD CROSSING] TRACKS	TRACKS	30X30 DIAMOND BLACK/YELW				
R1-2	YIELD	YIELD	36X36X36 TRIANGLE RED/WHIT				
R15-1	RAIL ROAD CROSSING	APTIL SORDED	48X9 CROSSBUCK BLACK/WHIT				
R4-4R	BEGIN RIGHT TURN	BEGIN RIGHT TURN LANE YIELD TO BIKES	36X30 RECTANGLE BLACK/WHIT				


SIGNI SCHEDHIE (CONT.)

SIGN SCHEDULE (CONT.)							
SIGN CODE	SIGN TEXT/ DESCREPTION	SIGN IMAGE	SIGN SIZE				
R1-1	STOP	STOP	30X30 OCTAGON WHITE/RED				
R1-3P	ALL WAY	ALL WAY	18X6 RECTANGLE WHITE/RED				
R3–17	BIKE, BIKE LANE	BIKE LANE	24X18 RECTANGLE WHITE/BLAK				
R3-17B	AHEAD	AHEAD	24X8 RECTANGLE BLACK/WHITE				
R3-17C	ENDS	ENDS	24X8 RECTANGLE BLACK/WHIT RED				
R3–7RB	RIGHT LANE MUST TURN RIGHT EXCEPT BUSES	RIGHT LANE MUST TURN RIGHT EXCEPT BUSES	30X30 SQUARE BLACK/WHIT				
R7–NP	NO PARKING	R	12X12 SQUARE WHIT/RED BLAK				
R7-NPL	NO PARKING W/LEFT ARROW						
R7-NPR	NO PARKING W/RIGHT ARROW	(()					
R7-PKP	NO PARKING 4–6PM EXC SAT–SUN–HOL TAZ	NO PARKING 4 - 6 PM EXEPTAGE ARE TOW-AWAY 200E PROFE ALL-LAGE	12X18 RECTANGLE RED/WHITE				
R7–S	SOUTH OF HERE	SOUTH OF HERE	12X12 SQUARE RED/WHIT				
R7-STOPS	NO STOPS, TOW AWAY ZONE Phone 684-5444		12X18 RECTANGLE RED/WHIT				

	REV'D		
	СНК'D		
	MADE		
	NATURE	REVISIONS	
	MARK		
	DATE		
	NO.		
	SERIAL	XXXX	
	VAULT		

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	APPROVED FOR ADVERTISING	INITIALS AND DATE	INITIALS AND DATE REVIEWED:	ST WARRING	Seattle
XXXX-XX	DEPARTMENT OF FINANCE & ADMINISTRATIVE SERVICES SEATTLE, WASHINGTON	CHECKED	DES. CONST. SDOT PROJ. MGR.		Department of Transportation
^^^		DRAWN	RECEIVED		
		CHECKED	REVISED AS BUILT	ARCISTERED	
	BY:	ALL WORK SHALL BE DONE IN ACCORDANCE WITH SPECIFICATIONS AND OTHER DOCUMENTS CALLED FO		VONAL ES	SCALE: H. 1"=20', V. 1"=10'

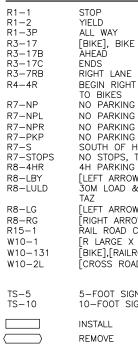

INSTALL

REMOVE RELOCATE/ MAINTAIN

SIGNING LEGEND

STOP YIELD ALL WAY [BIKE], BIKE LANE AHEAD

```
RIGHT LANE MUST TURN RIGHT EXCEPT BUSES
 BEGIN RIGHT TURN LANE [45R DW ARROW] YIELD
 NO PARKING W/LEFT ARROW
NO PARKING W/LEFT ARROW
NO PARKING W/RIGHT ARROW
NO PARKING 4-6PM EXC SAT-SUN-HOL TAZ
SOUTH OF HERE
NO STOPS, TOW AWAY ZONE PHONE:684-5444
4H PARKING 7A-6P EXC SUN-HOL
4H PARKING /A-6P EXC SUN-HOL

[LEFT ARROW]

30M LOAD & UNLOAD ONLY 7A-6P EXC SUN-HOL,

TAZ

[LEFT ARROW]


[RIGHT ARROW]

RAIL ROAD CROSSING

[RI LARGE X D]
[R LARGE X R]
[BIKE],[RAILROAD CROSSING] TRACKS
 [CROSS ROAD] [RR-XING LEFT]
5–FOOT SIGN POST PER STD PLAN NO 625
10–FOOT SIGN POST PER STD PLAN NO 625
```

SIGNAGE LEGEND AND SCHEDULE 01

	PC TRC1223 C0 TRC1223
GEORGETOWN TO	VPI # XXXX
DOWNTOWN PBL	SNDT01
	SHEET 78 OF 79

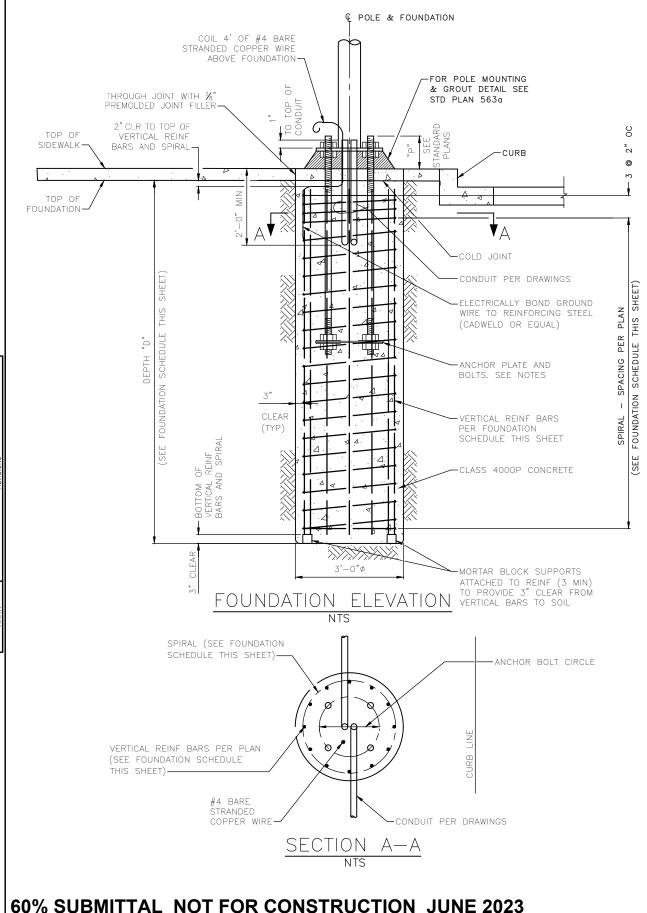

STRAIN POLE FOUNDATION SCHEDULE

LOCATION	POLE NO	DEPTH "D" (FT)	V EI (III O/ (E	SPIRAL REINFORCING	*DESIGN SPAN WIRE RESULTANT TENSILE FORCE (LB)
AIRPORT WY S/S LUCILE ST	PSG5-07	##	12 - #8	#3 © 6"	#.###
* SEE NOTE 4	•	•	•		


DOUBLE MAST ARMS POLE FOUNDATION SCHEDULE **

LOCATION	POLE NO	MAST ARM LENGTH (FT)	MAXIMUM XYZ (FT ³)	DEPTH "D" (FT)	VERTICAL REINFORCING	SPIRAL REINFORCING
6TH AVE S/S SPOKANE ST	PSG04-1	25	1130		12-#8	#3 © 6"
	PSG04-1	35	1610	##		

**SEE NOTE 7

NOTES:

- 1. FOUNDATION DESIGNED IN ACCORDANCE WITH THE AASHTO STANDARD SPECIFICATIONS FOR STRUCTURAL SUPPORTS FOR HIGHWAY SIGNS, LUMINAIRES, AND TRAFFIC SIGNALS, 6TH EDITION 2013. DESIGN BASIC WIND SPEED IS 85 MPH AND RECURRENCE INTERVAL/DESIGN LIFE IS 50 YEARS.
- 2. ANCHOR BOLTS MUST BE ASTM F1554 GR105. NUTS: ASTM A563 HEAVY HEX GRADE DH. HARDENED STEEL WASHERS: ASTM F436. HOT DIP GALVANIZE BOLTS AND FASTENERS PER ASTM F2329.
- 3. THE CONTRACTOR MUST SUBMIT SHOP DRAWINGS AND CALCULATIONS FOR POLE (INCLUDING WALL THICKNESS AND STEEL YIELD STRENGTH) AND POLE COMPONENTS PER SECTION 1-05.3, 8-32 AND 9-33. ANCHOR BOLTS SHALL BE DESIGNED BY POLE MANUFACTURER WITH A 20" BOLT CIRCLE. ANCHOR BOLT LENGTH, PROJECTION, AND ANCHOR PLATE PER STD. PLAN 541B FOR POLE TYPE X.
- 4. DESIGN SPAN WIRE TENSILE FORCE IS THE RESULTANT LOAD FROM BOTH SPAN WIRES AS SHOWN ON SHEET SG5 AND IS ASSUMED TO BE APPLIED AT 28.5' ABOVE TOP OF FOUNDATION. FOUNDATION DESIGN ALSO INCLUDES LOAD FROM WIND ON POLE. GOVERNING FOUNDATION LOADS ARE PER AASHTO LOAD GROUP II.
- 5. SPAN WIRE MUST BE 🖁, 7 STRAND ALUMINUM COVERED STEEL SPAN WIRE CONFIRMING TO ASTM B415 WITH MINIMUM RATED BREAKING STRENGTH OF 15,400 LBS. ALL HARDWARE AND CONNECTORS SHALL BE COMPATIBLE WITH THE SPAN WIRE SIZE
- 6. ALL REINFORCING BARS MUST BE DEFORMED BILLET STEEL CONFORMING TO ASTM A706, GRADE 60.
- 7. ANCHOR BOLTS FOR DOUBLE MAST ARM POLE MUST BE DESIGNED BY THE CONTRACTOR. THE MAXIMUM BOLT CIRCLE "A" SHALL NOT EXCEED 20". SEE STANDARD PLANS FOR OTHER FOUNDATION DETAILS.

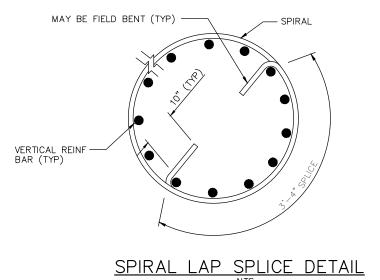

(PERMISSIBLE BELOW ANCHOR BOLTS)

GE 0 202

23.

UNE UNE

XXXX-XX	APPROVED FOR ADVERTISING DEPARTMENT OF FINANCE & ADMINISTRATIVE SERVICES SEATTLE, WASHINGTON	INITIALS AND DATE DESIGNED CHECKED	INITIALS AND DATE REVIEWED: DES. CONST. SDOT PROJ. MGR.		Seattle Department of Transportation
~~~~		CHECKED	RECEIVED REVISED AS BUILT THE CITY OF SEATTLE STANDARD PLANS AND IN IN SECTION 0-023 OF THE PROJECT MANUAL	Hora 45633 HORAL EVICE	ORDINANCE NO. PW NO. XXXX-XX SCALE: NOT TO SCALE

